DEVELOPMENT APPLICATION

DRAWING SCHEDULE

SPECIFICATIONS AND COMMENTS CLASS 1 AND 10 001

SITE ANALYSIS PLAN 010 DEMOLITION PLAN 011

PROPOSED SITE PLAN 012

PROPOSED BASEMENT FLOOR PLAN 100

PROPOSED GROUND FLOOR PLAN 101

PROPOSED ROOF PLAN 102

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FRONT FENCE DETAILS 600

DRIVEWAY GRADE DETAILS 620

LANDSCAPE AREA CALCULATION SHEET 900

GROSS FLOOR AREA CALCULATION SHEET 910

BASIX COMMITMENTS 920 NATHERS COMMITMENTS 930

NATHERS COMMITMENTS 931


SHADOW DIAGRAMS - 21st JUNE 940

3D VIEWS 950

REAR 3D VIEW 960

ISSUE DETAILS

A 03.07.25 ISSUED FOR DEVELOPMENT APPLICATION

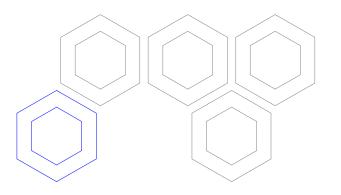



ADDITIONAL INFORMATION

A01 OWNER'S CONSENT FORM

A02 SURVEY PLAN

A03 BASIX & NATHERS CERTIFICATION

A04 STORMWATER PLAN

A05 LANDSCAPE PLAN

A06 STATEMENT OF ENVIRONMENTAL EFFECTS

407 WASTE MANAGEMENT PLAN

A08 QUANTITY SURVEYORS REPORT



PROPOSED DWELLING

4 CALDWELL PARADE, YAGOONA NSW 2199

ROLA EL ECHE





es.au

GENERAL REQUIREMENTS/SPECIFICATIONS CLASS 1 AND 10

BUILDING TO BE CONSTRUCTED IN ACCORDANCE WITH THE FOLLOWING/WHERE RELEVANT UNLESS AS OTHERWISE REQUIRED AND/OR SPECIFIED BY ANY RELEVANT PERFORMANCE SOLUTION REPORT

EARTHWORKS

NATIONAL CONSTRUCTION CODE (NCC)

• EARTHWORKS AND EXCAVATIONS ARE TO BE CARRIED OUT IN ACCORDANCE WITH BCA 2022 AMENDMENT 1 H1D3 AND HOUSING PROVISIONS PART 3.2

STORM WATER

- POWDER COATED ALUMINIUM GUTTERS & DOWNPIPES.
- REFER TO STORMWATER PLAN FOR ALL SITE DRAINAGE DETAILS AND CALCULATIONS.

NATIONAL CONSTRUCTION CODE (NCC)

- DRAINAGE IS TO BE IN ACCORDANCE WITH BCA 2022 AMENDMENT 1 H2D2
- ROOF, WALL CLADDING, GUTTERS & DOWNPIPES ARE TO COMPLY WITH BCA 2022 AMENDMENT 1

TERMITE PROTECTION

NATIONAL CONSTRUCTION CODE (NCC)

• PROTECTION MUST BE IN ACCORDANCE WITH BCA 2022 AMENDMENT 1 H1D3 AND ABCB HOUSING PROVISIONS PART 3.4

FOOTINGS AND SLABS

• PROPOSED FOOTINGS TO THE SPECIFICATIONS OF A QUALIFIED PRACTISING ENGINEER

NATIONAL CONSTRUCTION CODE (NCC)

• FOOTINGS AND SLABS ARE TO BE DESIGNED AND CONSTRUCTED IN ACCORDANCE WITH BCA 2022 AMENDMENT 1 H1D4 AND H2D3

AUSTRALIAN STANDARD (AS)

• PILED FOOTINGS ARE TO COMPLY WITH AS 2159-2009

- PROPOSED FLOOR CONSTRUCTION TO THE SPECIFICATIONS OF A QUALIFIED PRACTISING ENGINEER.
- ALL PORCHES, VERANDAHS & THE LIKE TO HAVE A 85mm STEPDOWN FROM INTERNAL AREAS UNLESS NOTED OTHERWISE
- FOR ALL REDUCED LEVELS REFER TO FLOOR PLANS (ENGINEERS DETAILS TO SUPERSEED-CONFIRM WITH DESIGNER)
- SUB FLOOR VENTILATION IS TO COMPLY WITH BCA 2022 AMENDMENT 1 H2D5

NATIONAL CONSTRUCTION CODE (NCC)

- STEEL AND TIMBER FRAMING AND STRUCTURAL STEEL SECTIONS ARE TO COMPLY WITH BCA 2022
- MASONRY, MASONRY COMPONENTS AND ACCESSORIES, AND WEATHERPROOFING OF MASONRY ARE TO COMPLY WITH BCA 2022 AMENDMENT 1 H1D5 AND H2D4
- SOUND INSULATION IS TO BE IN ACCORDANCE WITH BCA AMENDMENT 1 2022 H4D8
- REINFORCED AUTOCLAVED AERATED CONCRETE IS TO COMPLY WITH AS 5146.1-2015
- CONCRETE POST-INSTALLED AND CAST-IN FASTENINGS IS TO COMPLY WITH SA TA 101
- ROOF AND WALL CLADDING ARE TO COMPLY WITH BCA 2022 AMENDMENT 1 H2D6

NATIONAL CONSTRUCTION CODE (NCC)

- STAIR CONSTRUCTION IS TO COMPLY WITH PART 3.9.1
- STRUCTURAL DESIGN TO BE IN ACCORDANCE WITH ACCEPTABLE CONSTRUCTION MANUALS AS
- ATTACHMENT OF FRAMED DECKS AND BALCONIES TO EXTERNAL WALLS OF BUILDINGS USING A WALING PLATE IS TO COMPLY WITH BCA AMENDMENT 1 2022 H1D11

EXTERNAL WATERPROOFING

NATIONAL CONSTRUCTION CODE (NCC)

• EXTERNAL WATERPROOFING IS TO COMPLY WITH BCA AMENDMENT 1 2022 H2D8

- POWDER COATED ALUMINIUM FRAMED GLASS WINDOWS & DOORS UNLESS NOTED OTHERWISE. **NATIONAL CONSTRUCTION CODE (NCC)**
- ALL GLAZING IS TO BE IN ACCORDANCE WITH BCA 2022 AMENDMENT 1 H1D8 AND H2D7

NATIONAL CONSTRUCTION CODE (NCC)

• ROOF CLADDING SHALL BE CARRIED OUT IN ACCORDANCE WITH PART 3.5.1

AUSTRALIAN STANDARD (AS)

- INSTALLATION OF ROOF TILES AS 2050
- DESIGN & INSTALLATION OF SHEET ROOF & WALL CLADDING AS 1562.1

NATIONAL CONSTRUCTION CODE (NCC)

- THE FIRE HAZARD PROPERTIES OF MATERIALS ARE TO COMPLY WITH BCA 2022 AMENDMENT 1 H3D2
- FIRE SEPARATION OF EXTERNAL WALLS IS TO COMPLY WITH BCA 2022 AMENDMENT 1 H3D3
- FIRE PROTECTION OF SEPARATING WALLS AND FLOORS IS TO COMPLY WITH BCA 2022 AMENDMENT 1 H3D4
- FIRE SEPARATION OF GARAGE-TOP-DWELLINGS IS TO COMPLY WITH BCA 2022 AMENDMENT 1 H3D5
- SMOKE ALARMS AND EVACUATION LIGHTING ARE TO COMPLY WITH BCA 2022 AMENDMENT 1 H3D6

HEALTH & AMENITY

• ALL BATHROOM, ENSUITES AND LAUNDRIES TO HAVE FLOOR WASTES AND BE SETDOWN AND WATERPROOFED.

NATIONAL CONSTRUCTION CODE (NCC)

- WET AREAS ARE TO COMPLY WITH BCA 2022 AMENDMENT 1 H4D2
- MATERIALS AND INSTALLATION OF WET AREA COMPONENTS AND SYSTEMS ARE TO COMPLY WITH BCA 2022 AMENDMENT 1 H4D3
- ROOM HEIGHTS ARE TO COMPLY WITH BCA 2022 AMENDMENT 1 H4D4
- PROVISION OF LIGHT IS TO COMPLY WITH BCA 2022 AMENDMENT 1 H4D6
- PROVISION OF VENTILATION IS TO COMPLY WITH BCA 2022 AMENDMENT 1 H4D7
- SOUND INSULATION IS TO COMPLY WITH BCA 2022 AMENDMENT 1 H4D8
- CONDENSATION MANAGEMENT IS TO COMPLY WITH BCA 2022 AMENDMENT 1 H4D9

SAFE MOVEMENT & ACCESS

NATIONAL CONSTRUCTION CODE (NCC)

- STAIRWAY AND RAMP CONSTRUCTION ARE TO COMPLY WITH BCA 2022 AMENDMENT 1 H5D2
- BARRIERS AND HANDRAILS ARE TO COMPLY WITH BCA 2022 AMENDMENT 1 H5D3
- THE WINDOW IS TO BE FITTED WITH EITHER A DEVICE TO RESTRICT THE WINDOW OPENING. OR A SUITABLE SCREEN, SO A 125mm SPHERE CANNOT PASS THROUGH.
- THE DEVICE OR SCREEN CAN HAVE A CHILD RESISTANT RELEASE MECHANISM (E.G. A KEY LOCK) WHICH CAN ENABLE THE DEVICE OR SCREEN TO BE REMOVED, UNLOCKED OR OVERRIDDEN. (SO FOR EXAMPLE, THE WINDOW CAN BE CLEANED)
- A BARRIER IS NOT REQUIRED FOR WINDOWS 1.7m OR MORE ABOVE THE FLOOR LEVEL.

EXTERNAL FINISHES

• REFER TO SCHEDULE OF EXTERNAL MATERIALS, COLOURS AND FINISHES FOR MORE DETAILS.

ANCILLARY PROVISIONS AND ADDITIONAL CONSTRUCTION REQUIREMENTS

NATIONAL CONSTRUCTION CODE (NCC)

- SWIMMING POOLS ARE TO COMPLY WITH BCA 2022 AMENDMENT 1 NSW H7D2
- CONSTRUCTION IN BUSHFIRE PRONE AREAS IS TO COMPLY WITH BCA 2022 AMENDMENT 1 NSW H7D4
- HEATING APPLIANCES, FIREPLACES, CHIMNEYS AND FLUES ARE TO COMPLY WITH BCA 2022

• REFER TO LANDSCAPE PLAN FOR ALL PLANTING AND OUTDOOR SURFACE TREATMENTS

• THE RECOMMENDATIONS PROVIDED WITHIN THE BUSHFIRE ASSESSMENT REPORT ARE TO BE ADHERED TO. IN THE EVENT THAT THERE ARE INCONSISTENCIES, THE BUSHFIRE REPORT RECOMMENDATIONS ARE TO TAKE PRECEDENCE

NATIONAL CONSTRUCTION CODE (NCC)

• BUSHFIRE AREAS ARE TO BE IN ACCORDANCE WITH BCA 2022 AMENDMENT 1 H7D4

STRUCTURAL SOFTWARE USED IN COMPUTER AIDED DESIGN OF A BUILDING OR STRUCTURE THAT USES DESIGN CRITERIA BASED ON THE DEEMED-TO-SATISFY PROVISIONS OF NCC VOLUME TWO AND THE ABCB HOUSING PROVISIONS, INCLUDING ITS REFERENCED DOCUMENTS, FOR THE DESIGN OF STEEL OR TIMBER TRUSSED ROOF AND FLOOR SYSTEMS AND FRAMED BUILDING SYSTEMS, MUST COMPLY WITH THE ABCB PROTOCOL FOR STRUCTURAL SOFTWARE WHERE RELEVANT, AS REFERRED TO IN **ABCB HOUSING PROVISIONS PART 2.2.5**

THE DEVELOPMENT HAS BEEN DESIGNED TO BEST MEET THE GUIDELINES OF COUNCIL & THE NATIONAL CONSTRUCTION CODE

(ALL WORK ON SITE SHALL BE CARRIED OUT IN A SIMILAR MANNER TO ADHERE TO THE REQUIREMENTS OF COUNCIL AND THE NCC)


MINOR CHANGES TO BUILDING FORM AND CONFIGURATION MAY BE REQUIRED WHEN DRAWINGS ARE SUBSEQUENTLY PREPARED FOR CONSTRUCTION PURPOSES AFTER THE **GRANT OF DEVELOPMENT CONSENT**

NOT FOR CONSTRUCTION

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PROPOSED DWELLING | DRAWING

4 CALDWELL PARADE

DESIGN NATALI DUNDOVIC

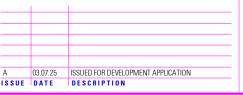
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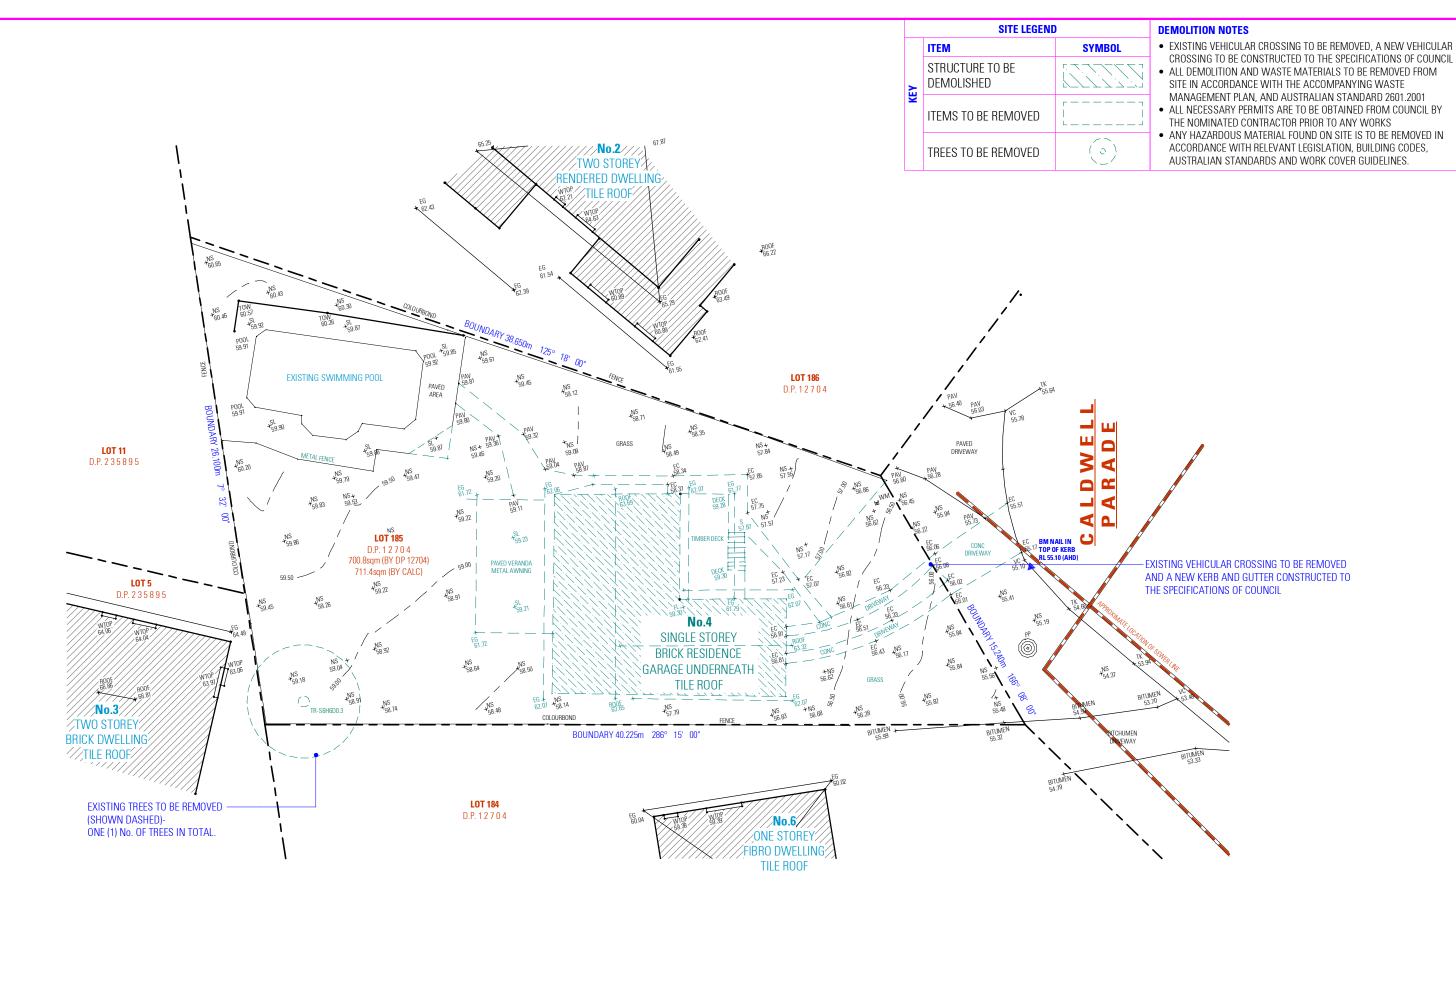
YAGOONA NSW 2199

SPECIFICATIONS AND COMMENTS CLASS 1 AND 10

ROLA FLECHE ISSUE A

DWG No. 24199 - 001



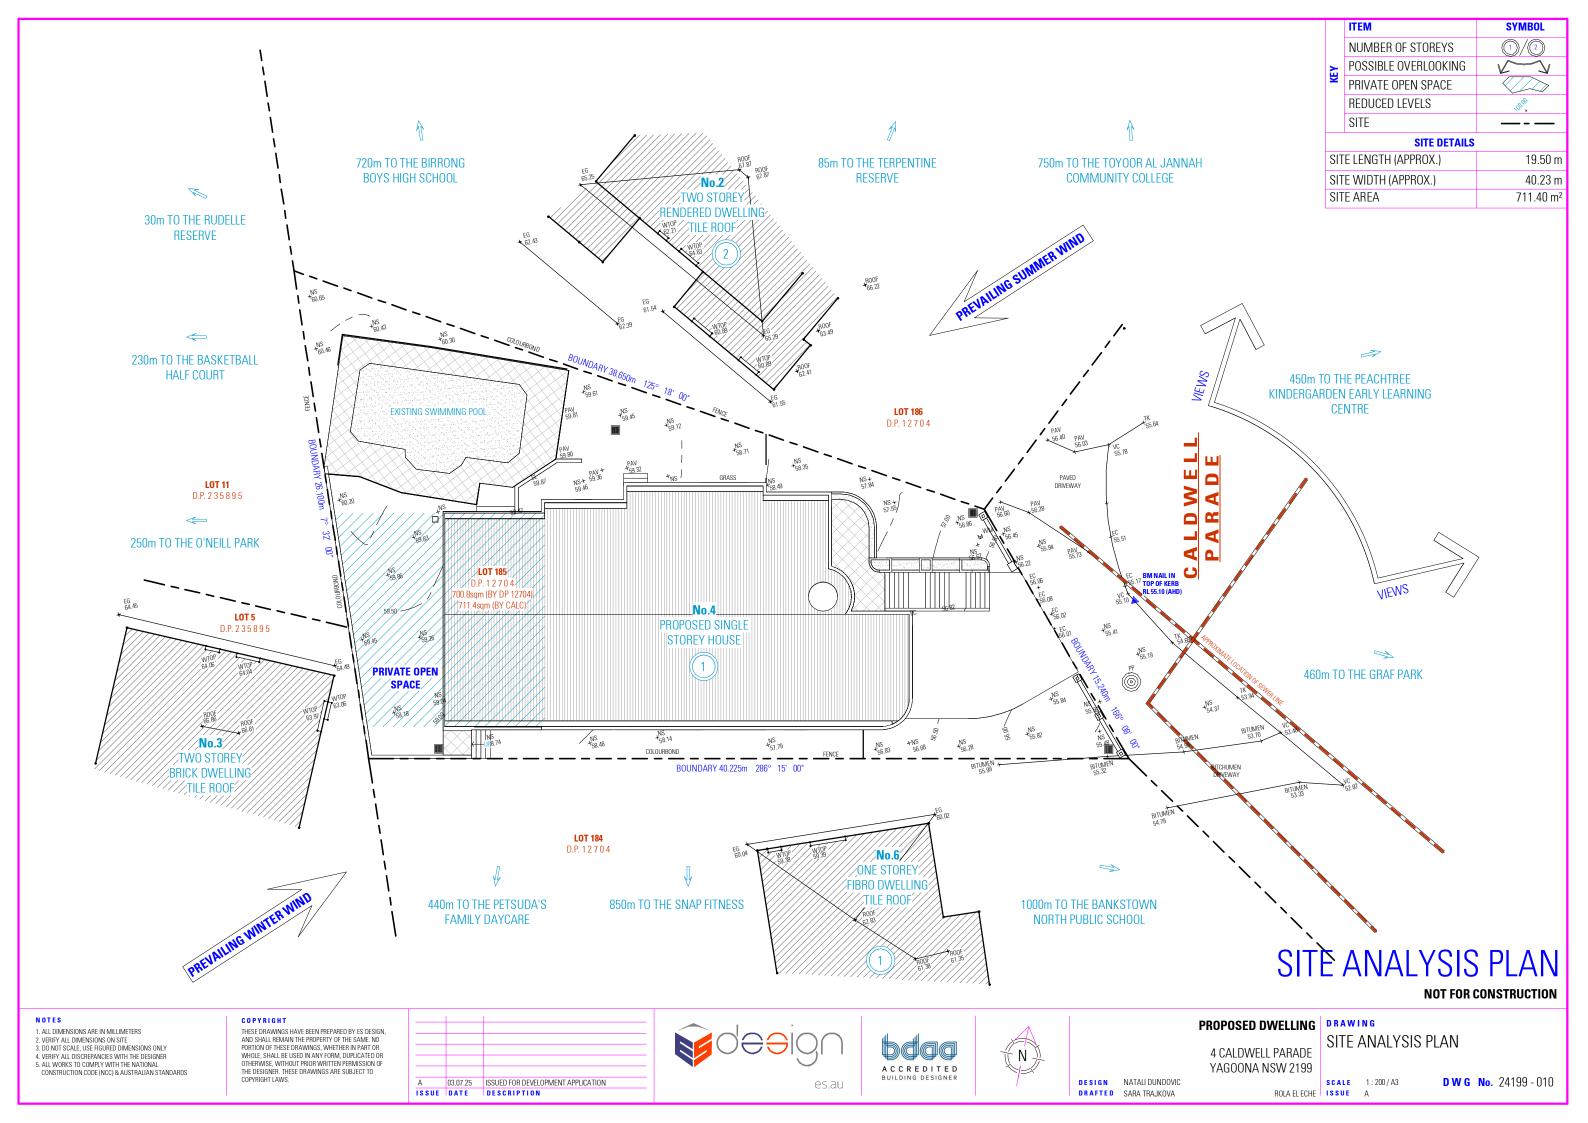


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PROPOSED DWELLING | DRAWING

4 CALDWELL PARADE

DEMOLITION PLAN


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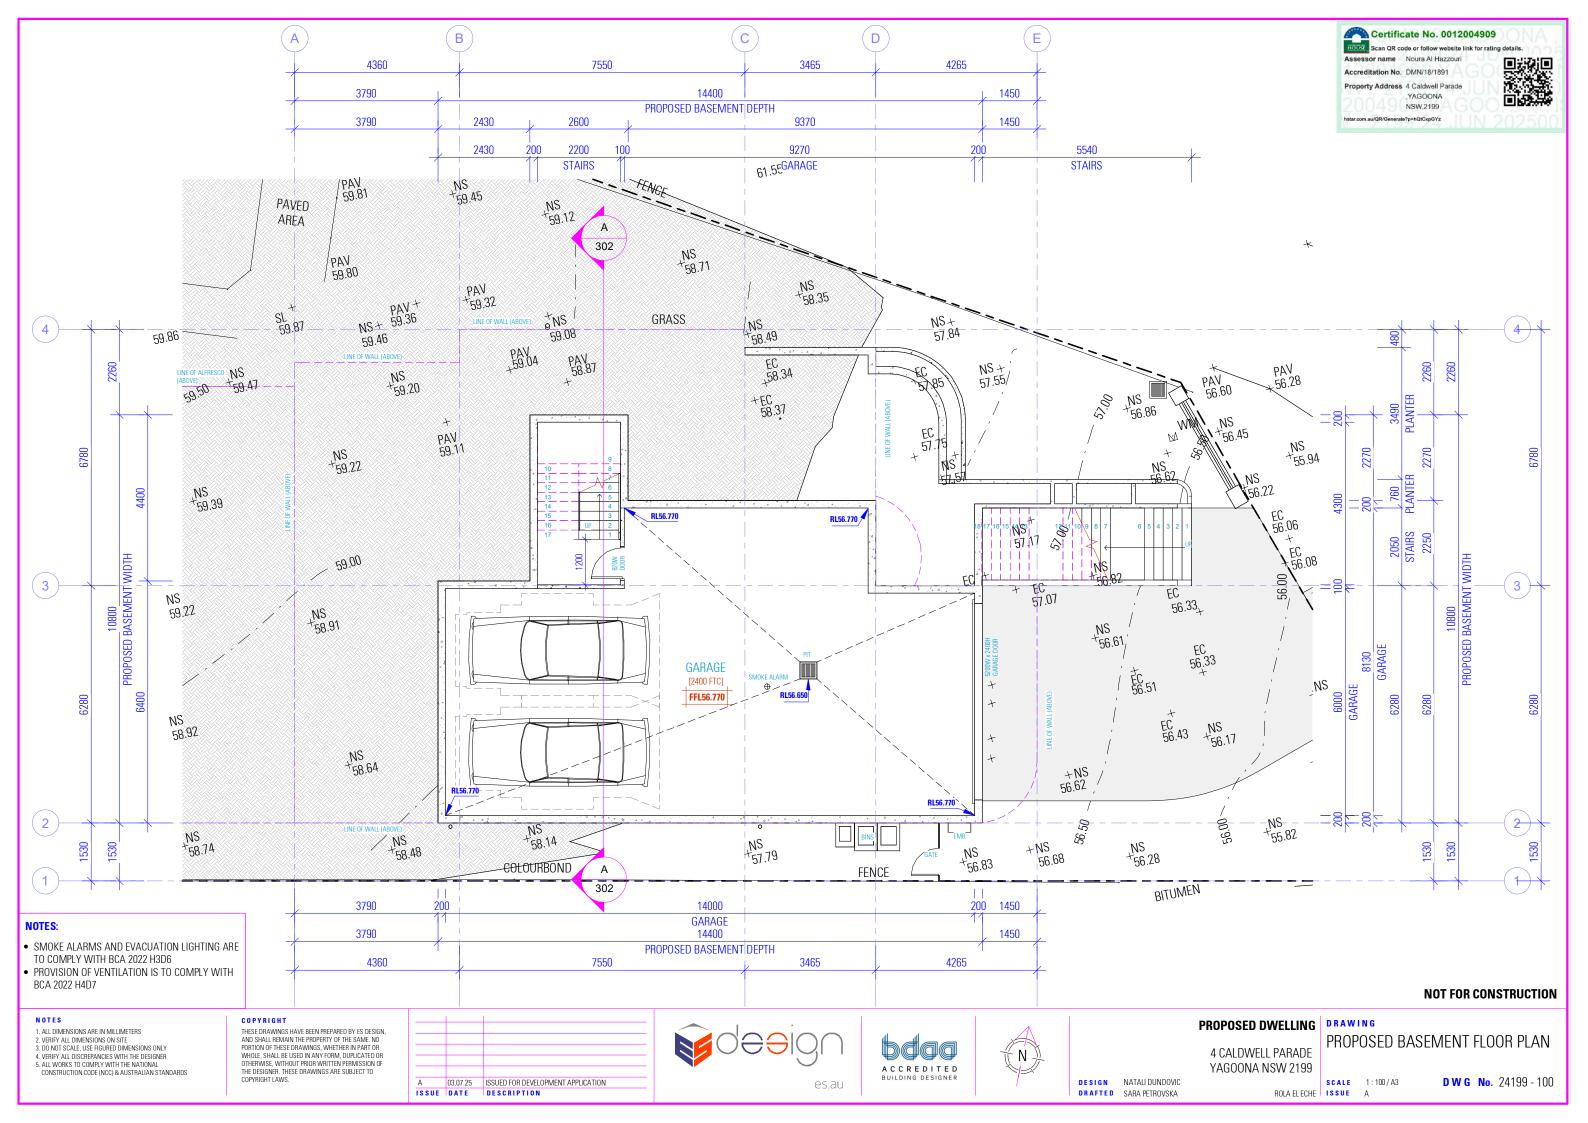
DWG No. 24199 - 011

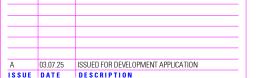
DESIGN NATALI DUNDOVIC


DRAFTED SARA PETROVSKA


ROLA EL ECHE ISSUE




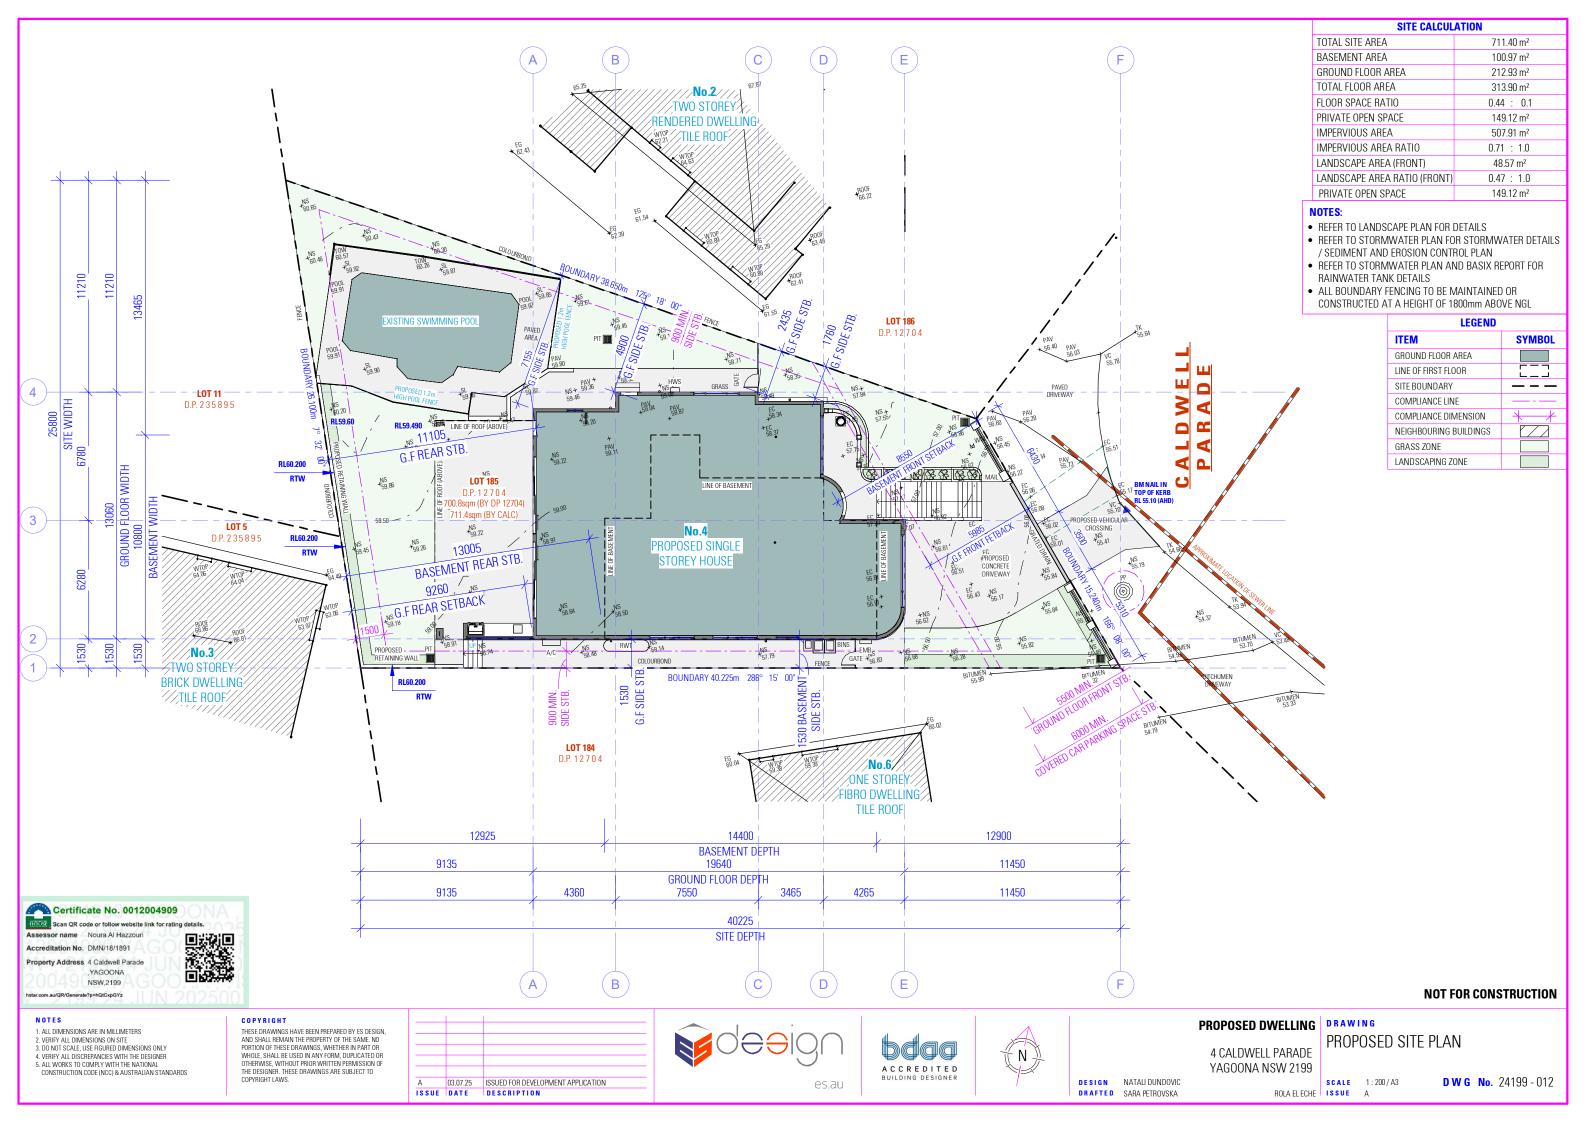

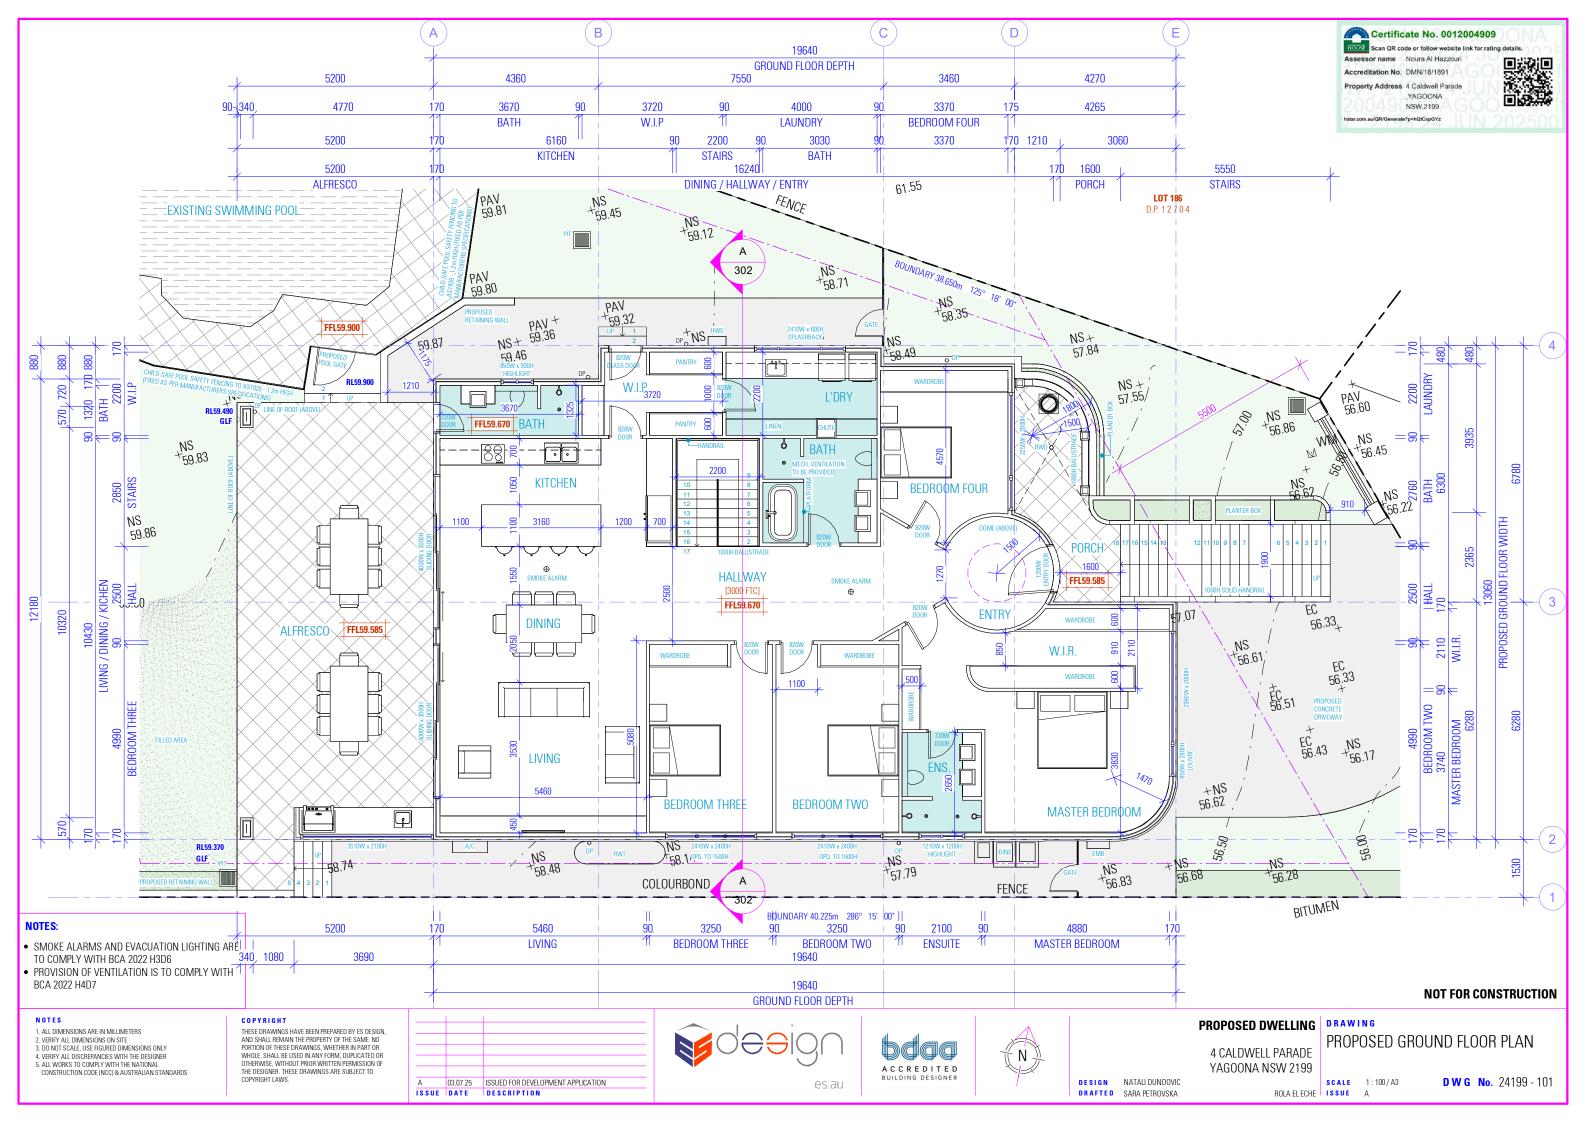

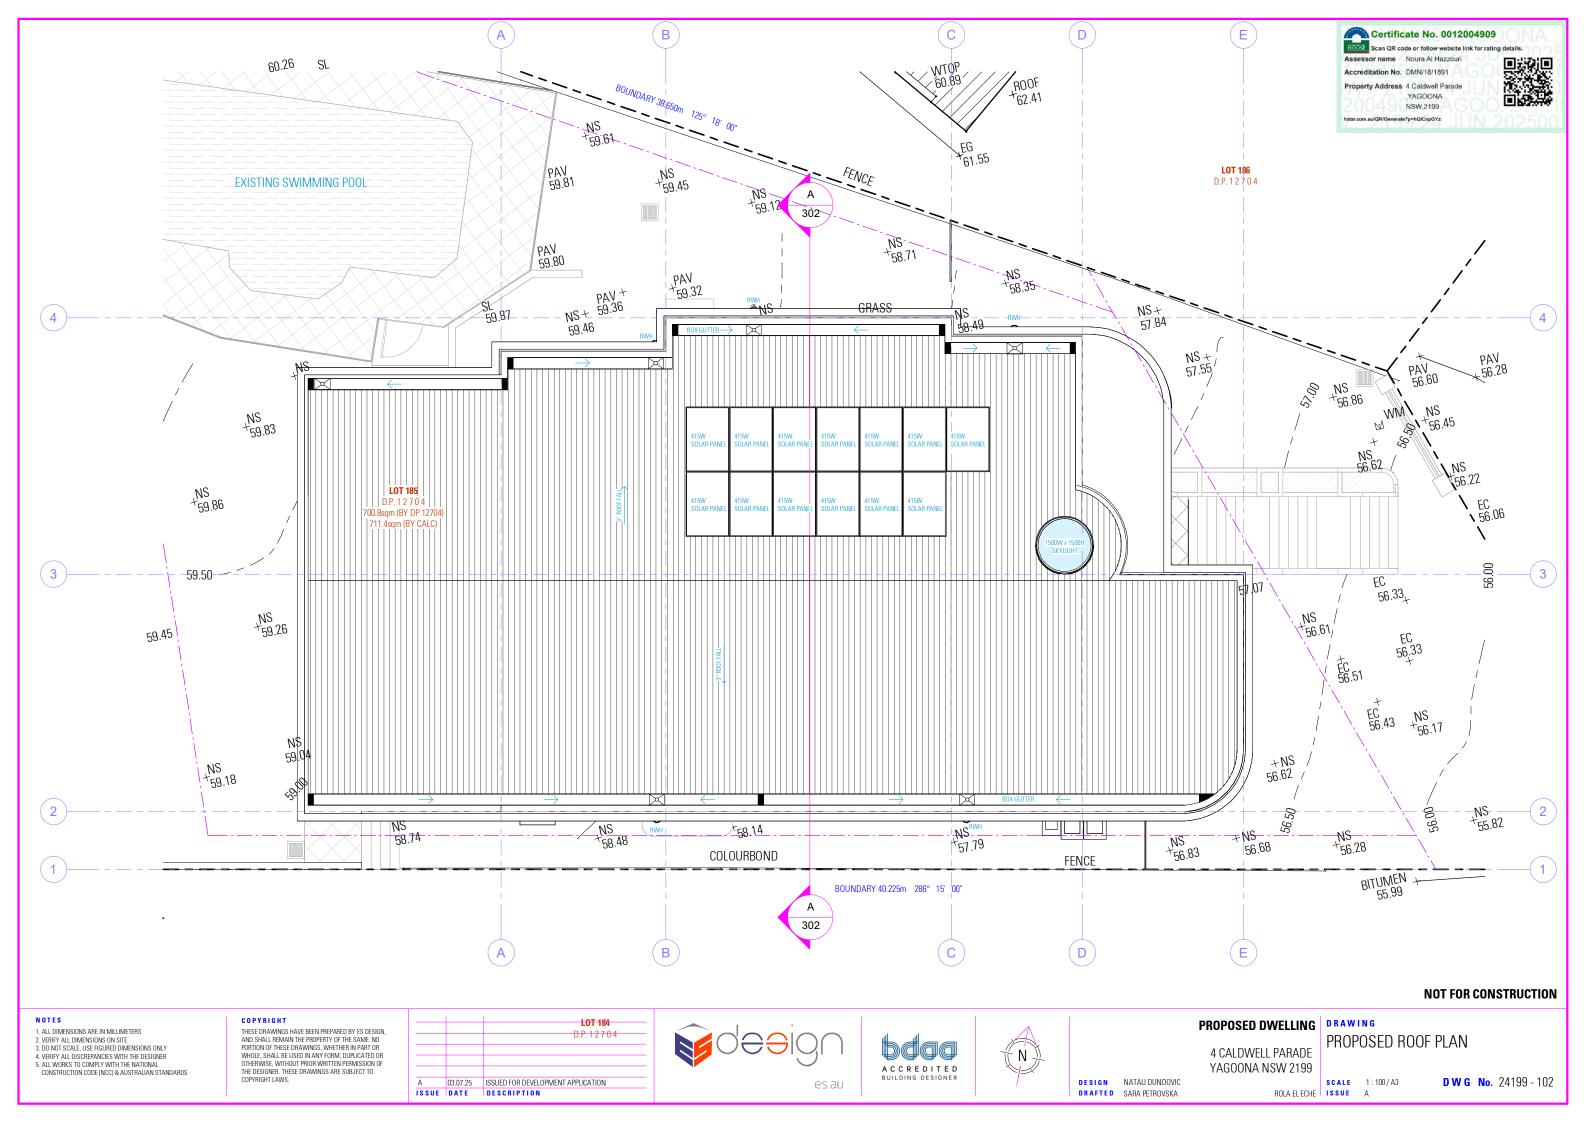

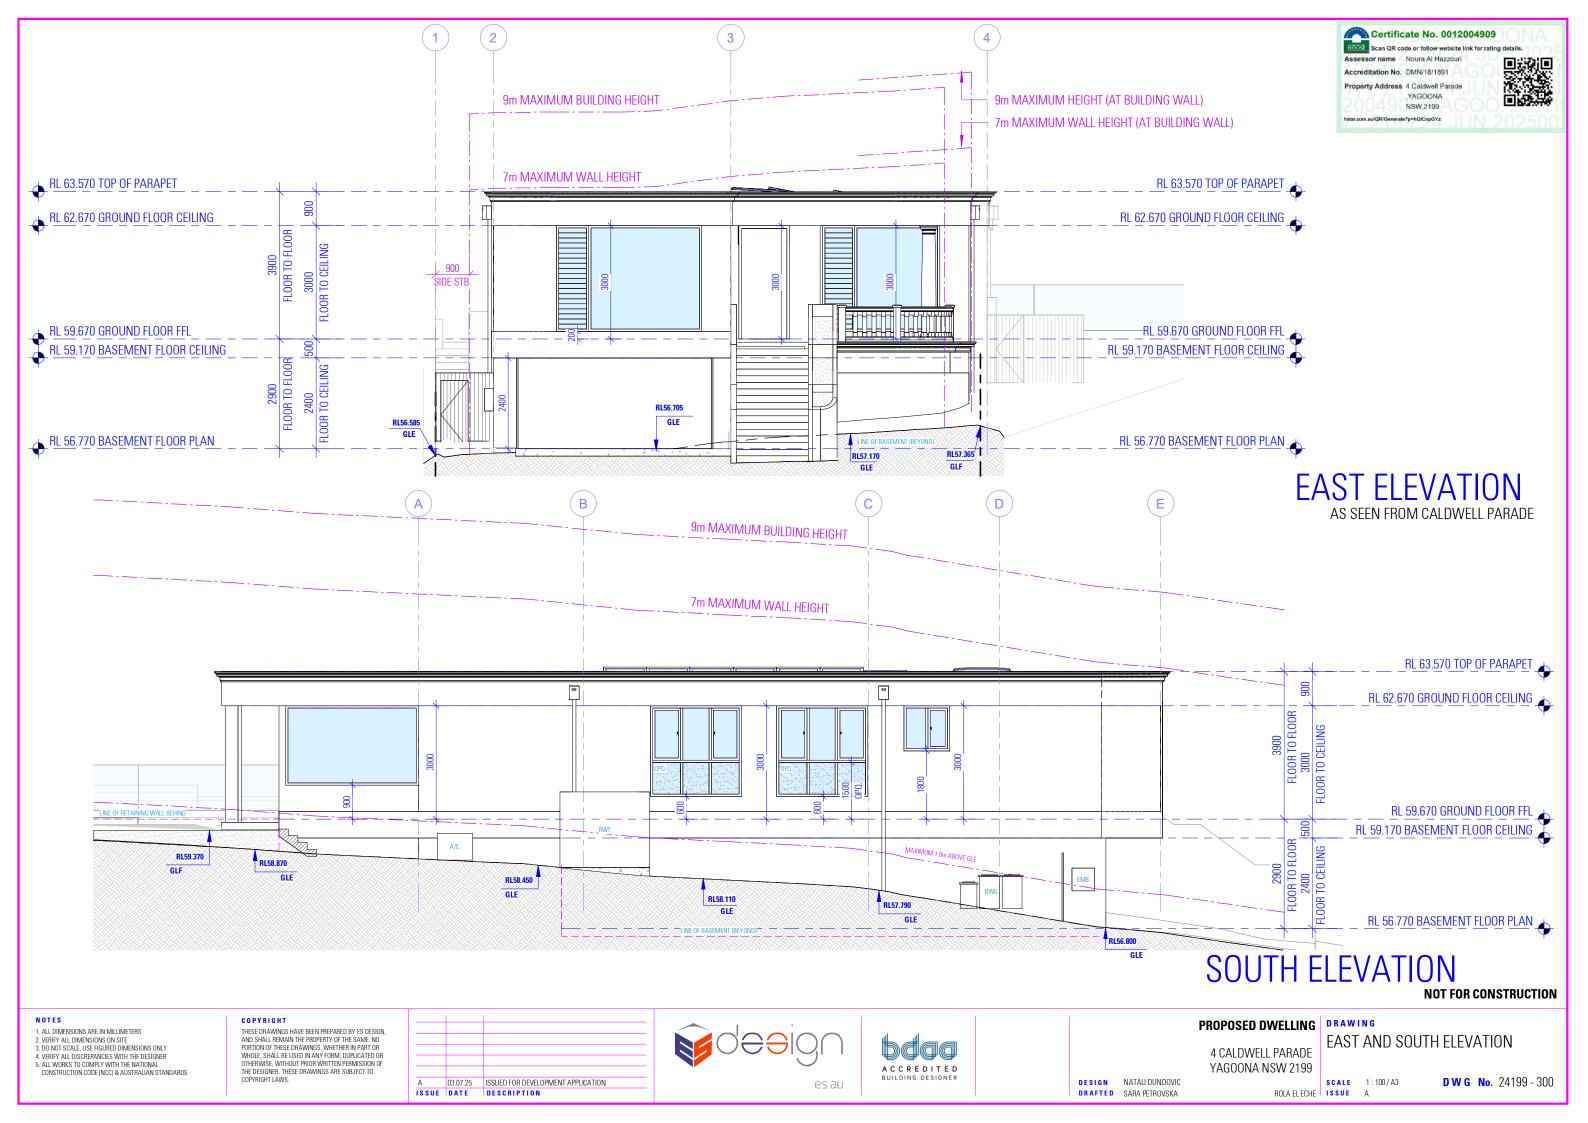

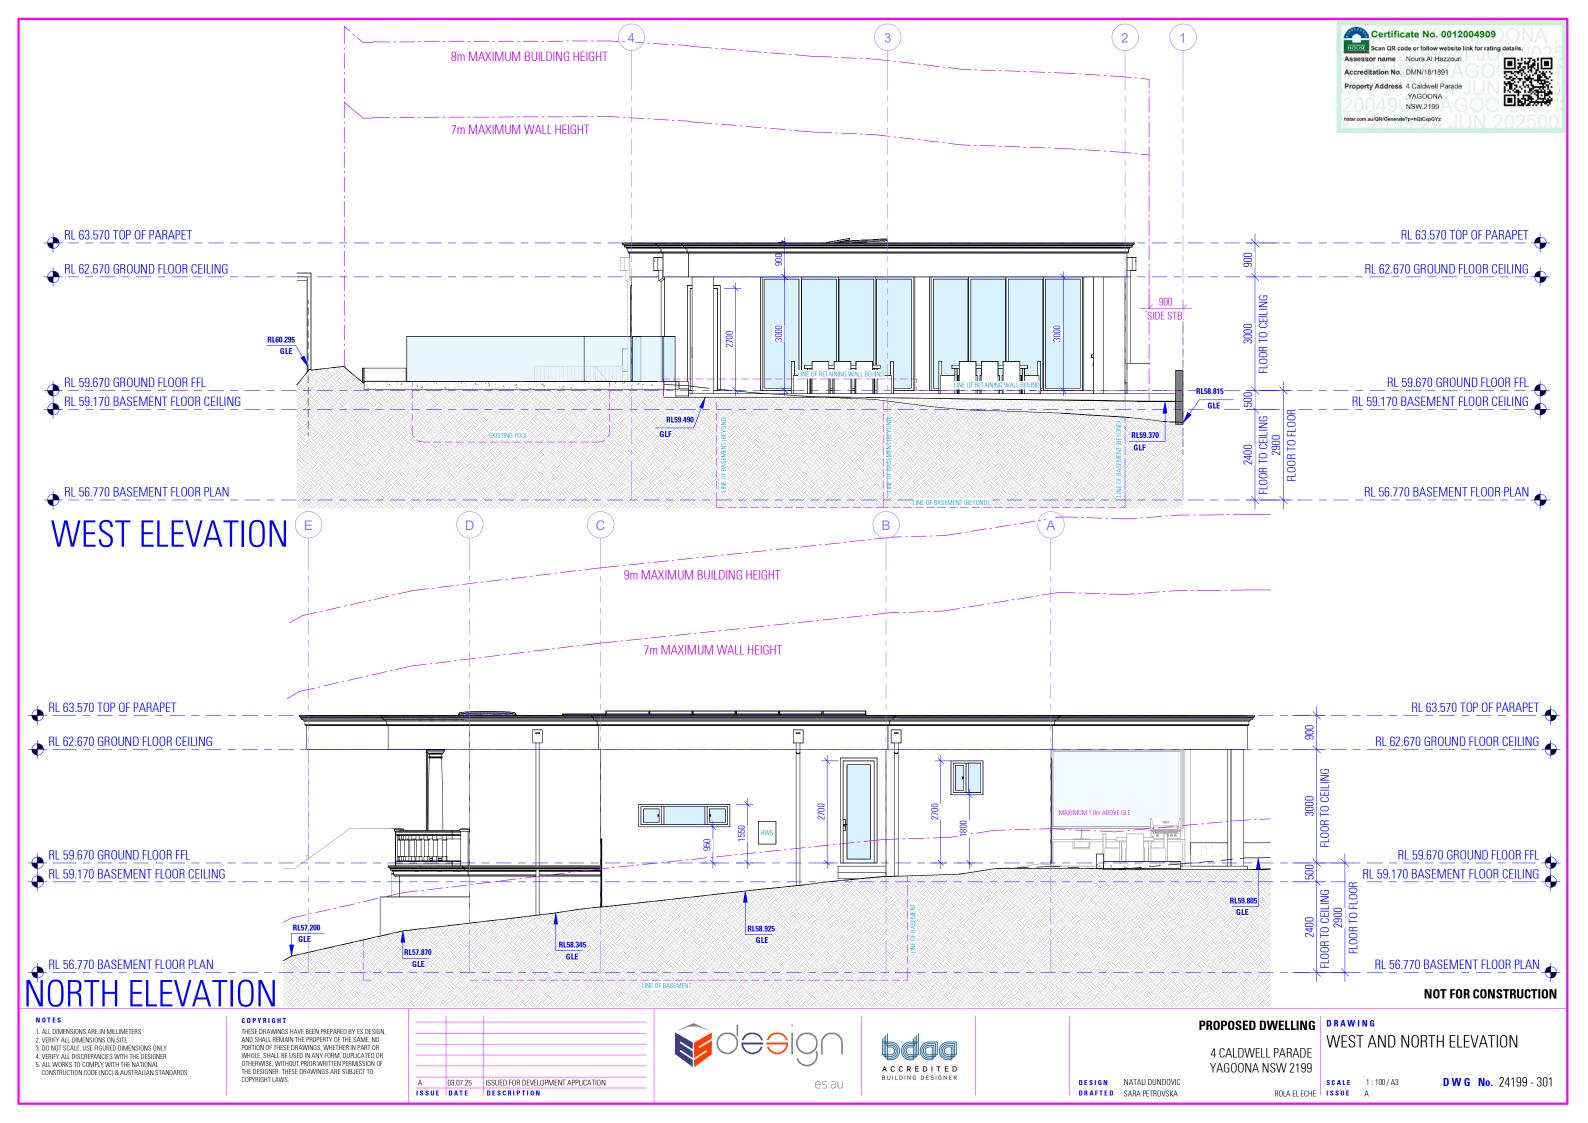

Certificate No. 0012004909 Accreditation No. DMN/18/1891


,YAGOONA NSW,2199

NOTES

1. THIS SCHEDULE DETAILS MAIN WALL COMPONENTS ONLY AND THE MEASUREMENTS GIVEN DO NOT INCLUDE RENDER, PLASTER OR THE LIKE. THEY ARE PROVIDED FOR "CONSTRUCTION" PURPOSES AND SUCH DO NOT REPRESENT THE FINAL WALL THICKNESS. 2. EXISTING WALLS SHOWN SOLID HATCHED.

3. THE ITEMS PROVIDED ABOVE ARE A GENERAL LIST OF WALL TYPES. VERIFY ALL DISCREPANCIES WITH THE DESIGNER BEFORE COMMENCING CONSTRUCTION.

4. REFER TO BASIX CERTIFICATE FOR INSULATION REQUIREMENTS.

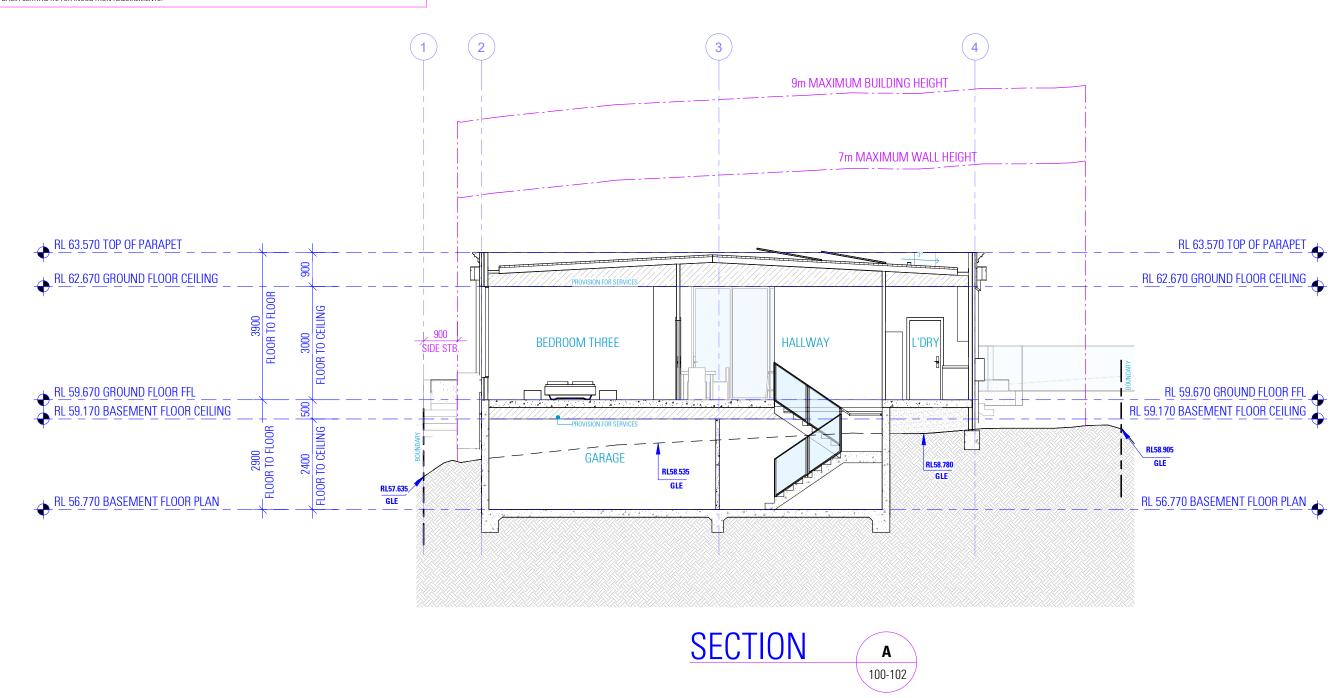

NOT FOR CONSTRUCTION

NOTES

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PROPOSED DWELLING | DRAWING

DESIGN NATALI DUNDOVIC

DRAFTED SARA PETROVSKA

4 CALDWELL PARADE YAGOONA NSW 2199

SECTION VIEW

SCALE 1:100/A3

ROLA EL ECHE ISSUE A

DW G No. 24199 - 302

1 CEMENT RENDER AND PAINT EXTERNAL FEATURES RANGE: COLOUR: OR ACCEPTABLE EQUIVALENT

2 STONE PANELS COLOUR: OR ACCEPTABLE EQUIVALENT

3 POWDER-COATED ALUMINIUM WINDOWS AND GLASS DOORS RANGE:

COLOUR: OR ACCEPTABLE EQUIVALENT

4 FLUSH MOUNT GARAGE DOOR RANGE: COLOUR: OR ACCEPTABLE EQUIVALENT

5 CEMENT RENDER AND PAINT EXTERNAL WALLS RANGE:

COLOUR: OR ACCEPTABLE EQUIVALENT

6 STONE PANELS EXTERNAL WALLS RANGE: OR ACCEPTABLE EQUIVALENT

7 ALUMINIUM ROOF SHEETING RANGE: OR ACCEPTABLE EQUIVALENT

8 ALUMINIUM GUTTERS AND DOWNPIPES RANGE: OR ACCEPTABLE EQUIVALENT

9 SOLID CORE TIMBER ENTRY DOORS

10 FEATURE COLUMN IN CEMENT RENDER COLOUR: OR ACCEPTABLE EQUIVALENT

SELECTED CONCRETE BALUSTRADING COLOUR: OR ACCEPTABLE EQUIVALENT

12 CEMENT RENDER AND PAINT EXTERNAL **FEATURES** COLOUR: OR ACCEPTABLE EQUIVALENT



AS SEEN FROM CALDWELL AVENUE

NOT FOR CONSTRUCTION

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II F	DATE	DESCRIPTION
	03.07.25	ISSUED FOR DEVELOPMENT APPLICATION





PROPOSED DWELLING DRAWING

4 CALDWELL PARADE YAGOONA NSW 2199

DESIGN NATALI DUNDOVIC


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SCHEDULE OF EXTERNAL MATERIALS, **COLOURS AND FINISHES**


ROLA EL ECHE ISSUE A

DW G No. 24199 - 320

FRONT FENCE DETAILS

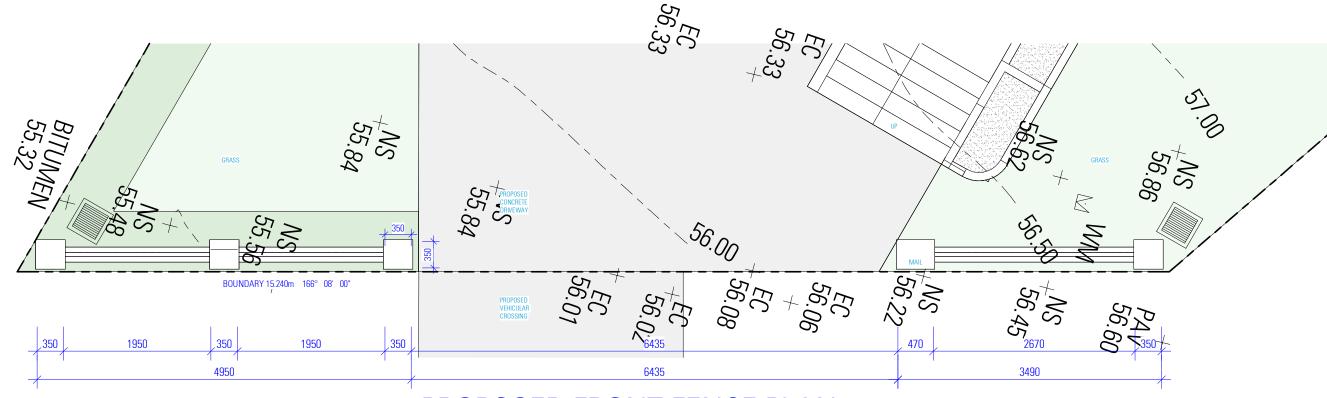

PROPOSED FRONT FENCE PLAN

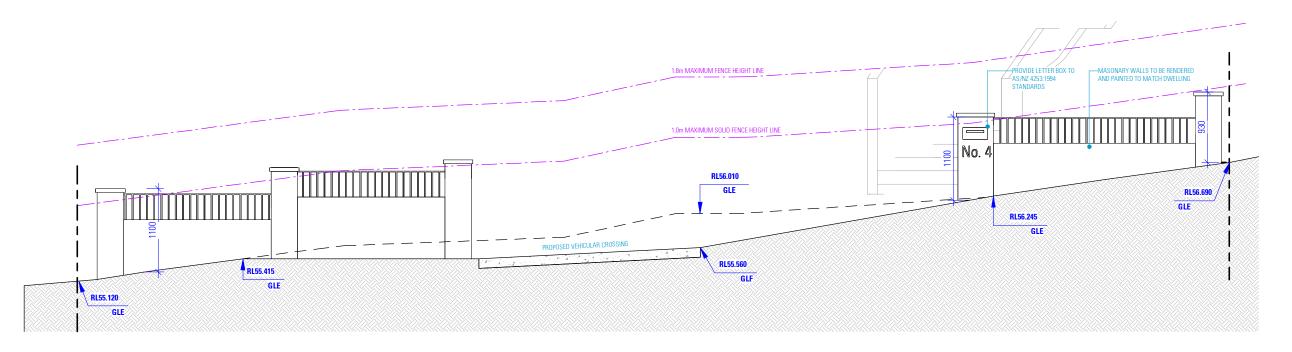

FRONT FENCE ELEVATION

NOT FOR CONSTRUCTION

NOTES

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PROPOSED DWELLING


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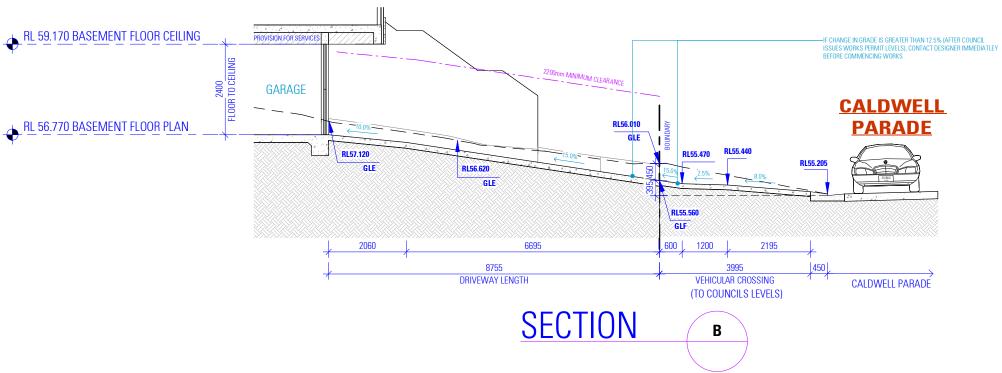
DRAWING

FRONT FENCE DETAILS

DWG No. 24199 - 600 ROLA EL ECHE ISSUE

DESIGN NATALI DUNDOVIC DRAFTED SARA PETROVSKA



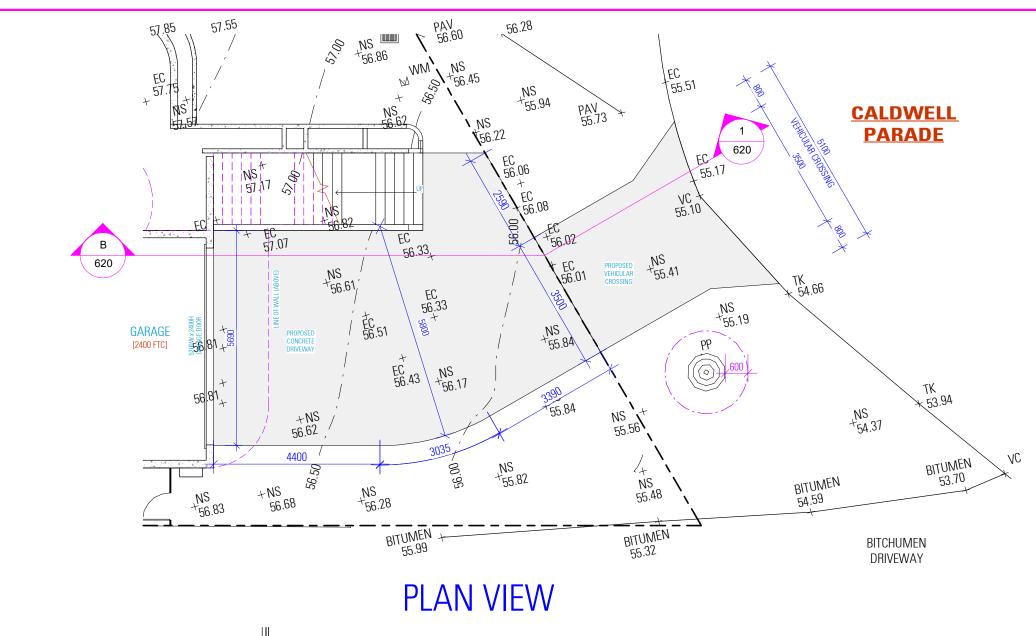

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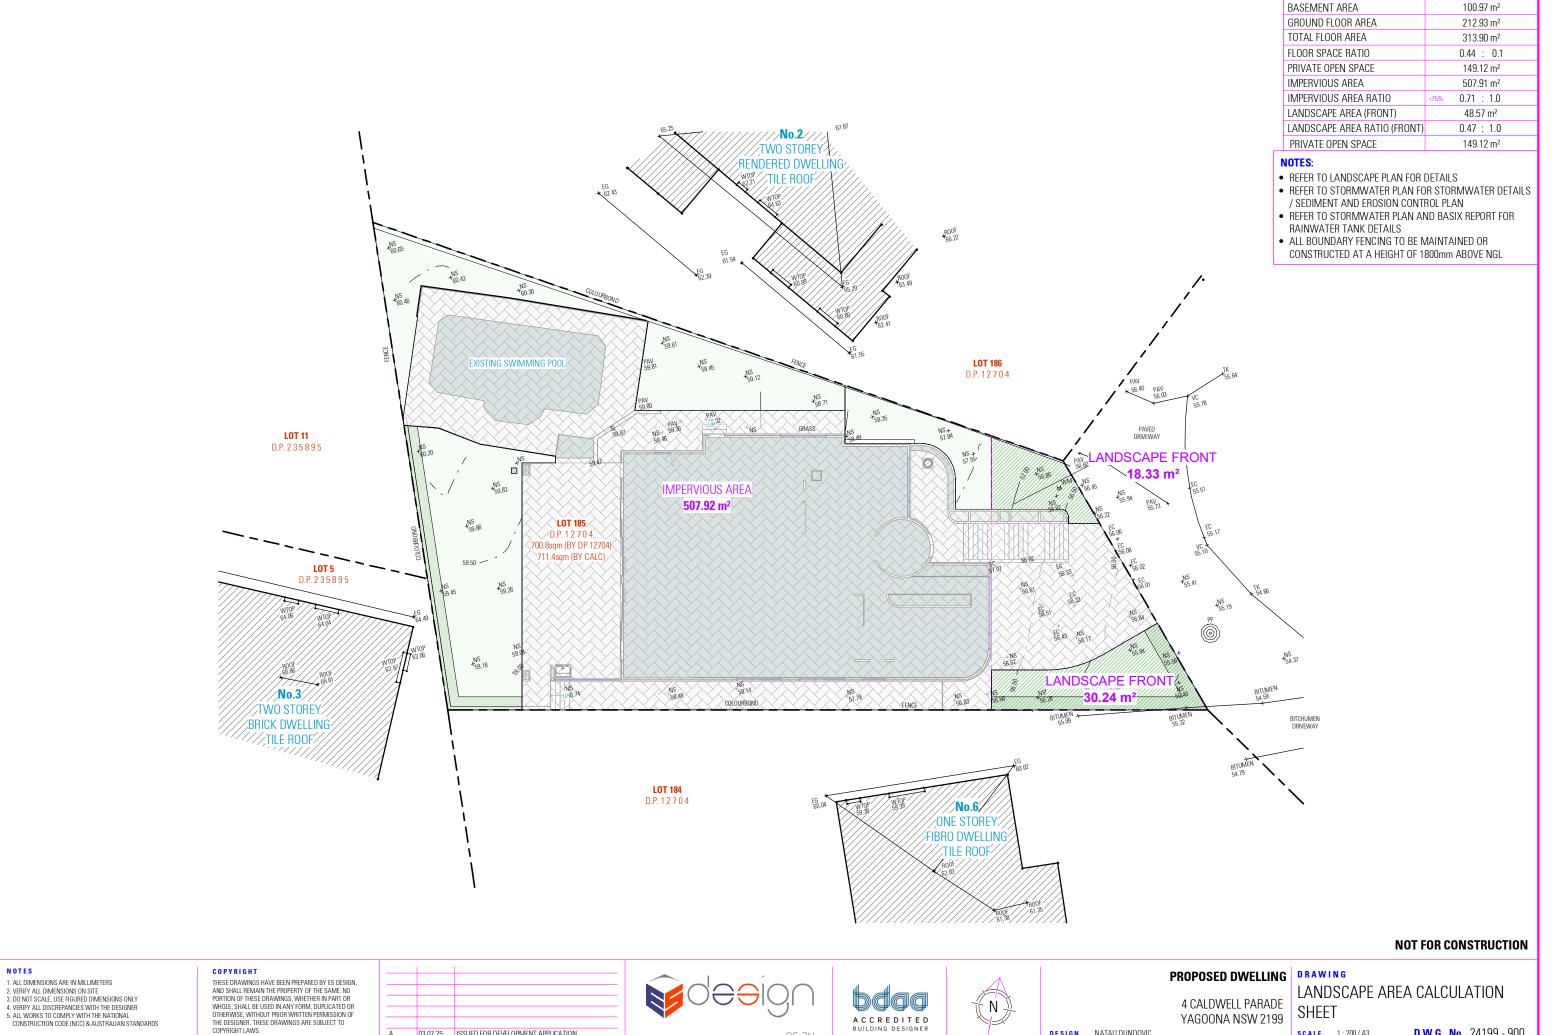
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DRIVEWAY GRADE DETAILS

ROLA EL ECHE ISSUE

DW G No. 24199 - 620

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NOTES

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03.07.25 ISSUED FOR DEVELOPMENT APPLICATION


SITE CALCULATION

711.40 m²

DWG No. 24199 - 900

ROLA EL ECHE ISSUE A

TOTAL SITE AREA

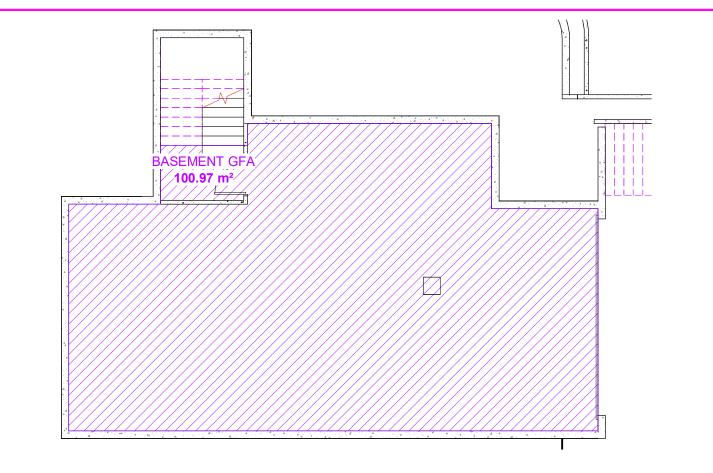

SITE CALCULATION			
TOTAL SITE AREA	711.40 m ²		
BASEMENT AREA	100.97 m ²		
GROUND FLOOR AREA	212.93 m ²		
TOTAL FLOOR AREA	313.90 m ²		
FLOOR SPACE RATIO	0.44 : 0.1		
PRIVATE OPEN SPACE	149.12 m ²		
IMPERVIOUS AREA	507.91 m ²		
IMPERVIOUS AREA RATIO	0.71 : 1.0		
LANDSCAPE AREA (FRONT)	48.57 m ²		
LANDSCAPE AREA RATIO (FRONT)	0.47 : 1.0		
PRIVATE OPEN SPACE	149.12 m ²		

NOTES:

- REFER TO LANDSCAPE PLAN FOR DETAILS
- REFER TO STORMWATER PLAN FOR STORMWATER DETAILS / SEDIMENT AND EROSION CONTROL PLAN
 • REFER TO STORMWATER PLAN AND BASIX REPORT FOR
- RAINWATER TANK DETAILS
- ALL BOUNDARY FENCING TO BE MAINTAINED OR CONSTRUCTED AT A HEIGHT OF 1800mm ABOVE NGL

BASEMENT GFA

GROUND FLOOR GFA

NOT FOR CONSTRUCTION

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GROUND FLOOR GFA 212.93 m²







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PROPOSED DWELLING DRAWING

4 CALDWELL PARADE YAGOONA NSW 2199

GROSS FLOOR AREA CALCULATION

DWG No. 24199 - 910

DESIGN NATALI DUNDOVIC

DRAFTED SARA PETROVSKA

ROLA EL ECHE ISSUE A

BASIX COMMITMENTS

BASIX™Certificate



Certificate Prepared by
Name / Company Name: Noura Al Hazzouri
ABN (if applicable):

✓ 100

Target 72

imulation Method	DA plans	plans & specs	check
sessor details and thermal loads			
se applicant must attach the conflicate referred to under "Assessor Details" on the front page of the BASIX conflictate (the "Assessor Details" on the front page of the BASIX conflictate (pitch excitations") to the development (pit either people excitations) to the development (pit either people excitations). The applicant must also attach the sessor Certificate for the application of an occupation certificate for the proposed development.			
e Assessor Certificate must have been issued by an Accredited Assessor in accordance with the Thermal Comfort Protocol.			
re details of the proposed development on the Assessor Certificate must be consistent with the details shown in this BASIX with the Cooling and Heating loads shown on the front page of this certificate and the "Construction" and "Glazing" bles below.			
e applicant must show on the plans accompanying the development application for the proposed development, all matters which Assessor Certificate requires to be shown on those plans. Those plans must bear a stamp of andorsement from the Accredited sesses to centify that this is the case. The applicant plans has not the plans accompanying the application for a construction strifficate (or complying development certificate), all thermal performance specifications set out in the Assessor entitions, and all aspects of the proposed wideologisms which were used to accludate those specifications.	~	~	~
e applicant must construct the development in accordance with all thermal performance specifications set out in the Assessor etificate, and in accordance with those aspects of the development application or application for a complying development certificate inch were used to calculate those specifications.		~	~
re applicant must show on the plans accompanying the development application for the proposed development, the locations of siling fans set out in the Assessor Certificate. The applicant must show on the plans accompanying the application for a construction strifficate (or complying development certificate, if a pliciable), the locations of ceiling fans set out in the Assessor Certificate.	~	~	~

Energy Commitments	Show on DA plans	Show on CC/CDC plans & specs	Certifier check
Hot water			
The applicant must install the following hot water system in the development, or a system with a higher energy rating: electric instantaneous.	~	~	~
Cooling system			
The applicant must install the following cooling system, or a system with a higher energy rating, in at least 1 living area: 1-phase airconditioning - ducted; Energy rating: 2 star (average zone)		~	~
The applicant must install the following cooling system, or a system with a higher energy rating, in at least 1 bedroom: 1-phase airconditioning - ducted; Energy rating: 2 star (average zone)		~	~
Heating system			
The applicant must install the following heating system, or a system with a higher energy rating, in at least 1 living area: 1-phase airconditioning - ducted; Energy rating: 2 star (average zone)		~	~
The applicant must install the following heating system, or a system with a higher energy rating, in at least 1 bedroom: 1-phase airconditioning - ducted; Energy rating: 2 star (average zone)		~	~
Ventilation			
The applicant must install the following exhaust systems in the development:			
At least 1 Bathroom: individual fan, ducted to façade or roof; Operation control: manual switch on/off		~	_
Kitchen: individual fan, ducted to façade or roof, Operation control: manual switch on/off		•	-
Laundry: individual fan, ducted to façade or roof; Operation control: manual switch on/off		•	-
Artificial lighting			
The applicant must ensure that a minimum of 80% of light fixtures are fitted with fluorescent, compact fluorescent, or light-emitting- diode (LED) lamps.		~	~
Natural lighting			
The applicant must install a window and/or skylight in the kitchen of the dwelling for natural lighting.			-

Description of project

Project address		
Project name	4_cal	
Street address	4 CALDWELL Parade YAGOONA 2199	
Local Government Area	Canterbury-Bankstown Council	
Plan type and plan number	Deposited Plan DP12704	
Lot no.	185	
Section no.	-	
Project type		
Project type	dwelling house (detached)	
No. of bedrooms	4	
Site details		
Site area (m²)	711	
Roof area (m²)	310	
Conditioned floor area (m²)	201.7	
Unconditioned floor area (m²)	14.5	
Total area of garden and lawn (m²)	149	

NatHERS assessor number DMN/18/1891			
NatHERS certificate number	0012004909		
Climate zone	56		
Area adjusted cooling load (MJ/ m².year)	13		
Area adjusted heating load (MJ/ m².year)	17		
Project score			
Water	✓ 41	Target 40	
Thermal Performance	✓ Pass	Target Pass	
Energy	✓ 100	Target 72	
Materials	✓ -62	Target n/a	

Roof area of the existing dwelling (m²) 0

Thermal Performance and Materials commitments	Show on DA plans	Show on CC/CDC plans & specs	Certifier check
Construction			
The applicant must construct the floors, walls, roofs, ceilings and glazing of the dwelling in accordance with the specifications listed in the tables below.	>	~	~
The applicant must show through receipts that the materials purchased for construction are consistent with the specifications listed in			

construction	Area - m²	Insulation
oor - concrete slab on ground, conventional slab.	102	expanding foam
oor - suspended floor above enclosed subfloor, concrete - suspended; frame: no frame.	107	expanding foam
arage floor - concrete slab on ground.	98.6	expanding foam
external wall: framed (solid or reconstituted timber weatherboard); frame: timber - H2 treated softwood.	all external walls	fibreglass batts or roll+ foil/sarking
external garage wall: concrete block/plasterboard; frame: no frame.	65	fibreglass batts or roll
nternal wall: plasterboard; frame: timber - H2 treated softwood.	86	none
ceiling and roof - flat ceiling / flat roof, concrete - plasterboard internal, timber - H2 treated softwood.	310	ceiling: fibreglass batts or roll; roof: foil/sarking.

he applicant must install a fixed outdoor clothes drying line as part of the development. he applicant must install a fixed indoor or sheltered clothes drying line as part of the developmen

Schedule of BASIX commitments

The commitments set out below regulate how the proposed development is to be carried out. It is a condition of any development consent granted, or complying development certificate issued, for the proposed development, that BASIX commitments be complied with.

Water Commitments	Show on DA plans	Show on CC/CDC plans & specs	Certifie check
Fixtures			
The applicant must install showerheads with a minimum rating of 4 star (> 4.5 but <= 6 L/min plus spray force and/or coverage tests) in all showers in the development.		~	-
The applicant must install a toilet flushing system with a minimum rating of 4 star in each toilet in the development.		~	~
The applicant must install taps with a minimum rating of 5 star in the kitchen in the development.		~	
The applicant must install basin taps with a minimum rating of 5 star in each bathroom in the development.		~	
Alternative water			
Rainwater tank			
The applicant must install a rainwater tank of at least 1500 litres on the site. This rainwater tank must meet, and be installed in accordance with, the requirements of all applicable regulatory authorities.	~	~	-
The applicant must configure the rainwater tank to collect rain runoff from at least 80 square metres of the roof area of the development (excluding the area of the roof which drains to any stormwater tank or private dam).		~	~
The applicant must connect the rainwater tank to:			
all toilets in the development		~	-
 at least one outdoor tap in the development (Note: NSW Health does not recommend that rainwater be used for human consumption in areas with potable water supply.) 		~	v

Frames	Maximum area - m2
aluminium	62.4
timber	0
uPVC	0
steel	0
composite	0
	l.

	Glazing	Maximum area - m2
	single	7.9
	double	54.5
	triple	0

DESIGN NATALI DUNDOVIC DRAFTED SARA PETROVSKA

NOT FOR CONSTRUCTION


NOTES

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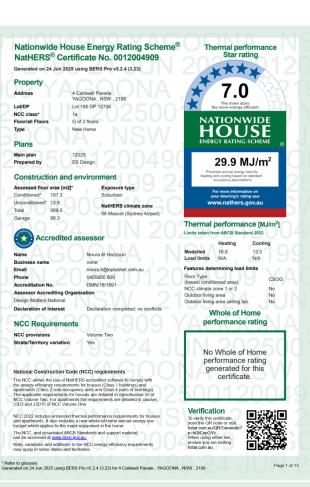
PROPOSED DWELLING DRAWING

4 CALDWELL PARADE YAGOONA NSW 2199

BASIX COMMITMENTS

ROLA EL ECHE ISSUE A

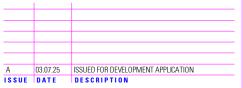
DWG No. 24199 - 920







Location	HERS Certificate Window ID	7 Star Rating Window no.	as of 24 Jun Height [mm]		Window type	Opening %	Orientation	Window shading device*
Master Bedroo	m ALM-004-03	A W4	2800	850	Louvre	90	E	No
master ens	ALM-002-01	A W5	1200	1210	Sliding	45	S	No
Bedroom 2	ALM-004-03	A W6	2400	2410	Sliding	30	s	No
Bedroom 3	ALM-004-03	A W7	2400	2410	Sliding	30	s	No
Kitchen/Living	ALM-004-03	A W8	3000	4000	Sliding	75	W	No
Kitchen/Living	ALM-004-03	A W9	3000	4000	Sliding	75	W	No
bath	ALM-001-03	A W10	2700	720	Casement	90	W	No
bath	ALM-002-01	A W11	900	850	Sliding	45	N	No
Wip	ALM-001-03	A W12	2700	820	Casement	90	N	No
ldry	ALM-002-01	A W13	600	2410	Sliding	45	N	No
Bedroom 4	ALM-004-03	A W1	2800	2250	Fixed	00	E	No
Bedroom 4	ALM-004-03	A W2	2250	850	Louvre	90	E	No
Default roof win	low* type and p dows* Window Description	oerformance Maxim U-val	num	SHGC	* SHG	Substitution C lower limit	ı tolerance rai SHGC i	nges upper limit
Default roof win Window ID No Data Availa	windows* Window Description	Maxim	num	SHGC	SHO			
Default roof win	dows* Window Description ble indows* Window	Maxim	num ue*	SHGC	SHG	C lower limit	SHGC	upper limit
Default roof win Window ID No Data Availa Custom roof win	Window Description ble andows* Window Description	Maxim U-val	num ue*		SHG	C lower limit	SHGC	upper limit
Default roof win Window ID No Data Availa Custom roof win Window ID No Data Availa Roof wind	Window Description ble andows* Window Description	Maxin U-val Maxin U-val	num ue* num ue*		SHO	Substitution	SHGC	nges upper limit
Default roof win Window ID No Data Availa Custom roof win Window ID No Data Availa Roof wind Location	window be window be be windows window be be windows window be be windows window window window window window window no.	Maxin U-val Maxin U-val	num ue* num ue*	SHGC	SHO	C lower limit	SHGC	upper limit nges upper limit
Default roof win Window ID No Data Availa Custom roof win Window ID No Data Availa Roof Wind	window be window be be windows window be be windows window be be windows window window window window window window no.	Maxin U-val Maxin U-val	num ue* num ue*	SHGC	SHO	Substitution	SHGC Interest of the state of the shape of t	nges upper limit
Default roof win Window ID No Data Availa Custom roof wit Window ID No Data Availa Roof wind Location No Data Availa Skylight* (Windows* Window Description Dele Window Description Window Description Dele Window Description Dele Window Window Window Description Dele Window Window Window Description Dele Window Window Window Window Description Dele	Maxim U-val Maxim U-val	num ue* num ue*	SHGC	SHO	Substitution Clower limit	SHGC III tolerance ran SHGC III	nges upper limit
Default roof win Window ID No Data Availa Custom roof win Window ID No Data Availa Roof wind Location No Data Availa Skylight* { Skylight ID	Window Description ble windows* Window Description ble Window Description ble Window Window Window Description ble Window Window Window Description ble Window Window Window Description Skylight description	Maxim U-val Maxim U-val Maxim U-val	num num ue*	SHGC eight mm]	SHO	Substitution Clower limit	SHGC Interest of the state of the shape of t	nges upper limit
Default roof win Window ID No Data Availa Custom roof win Window ID No Data Availa Roof wind Location No Data Availa	Window Description ble windows* Window Description ble Window Description ble Window Window Window Description ble Window Window Window Description ble Window Window Window Description Skylight description	Maxim U-val Maxim U-val	num num ue*	SHGC eight mm]	SHO	Substitution Clower limit	SHGC III tolerance ran SHGC III	nges upper limit

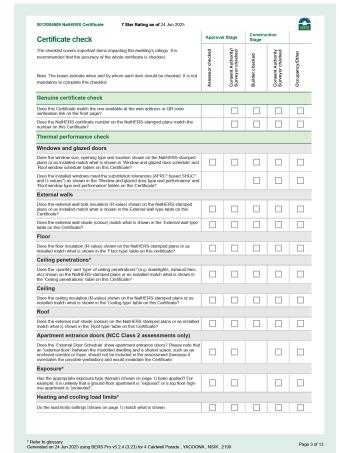

0012004909 Na	atHERS Certificate	7 Star	Rating a	s of 24 Jun 2025				110
Skylight*	schedule							
Location	Skylight ID	Skyligh No.	ht	Skylight shaft length [mm]	Area [m²]	Orientation	Outdoor shade	Diffuser
entry	GEN-04-009a	S1		50	2.25	s	None	No
External of	door schedule	9						
Location	Heigh	nt [mm]		Width [mm]		Opening %	Orientatio	on
Garage		400		5200		90	Е	
entry	3	000		1350		90	E	
External	wall type							
Wall Wall ID type			a	Solar Wall		ulk insulation R-value]		Reflecti wall wra
	Concrete, Lined Tim	nber Stud Fr		0.50		Bulk Insulation, Air	Gap R1.5	No
EW-2 Stone								
External	wall schedule	Height	Width	0.50	Но	erizontal shading	Vertical s	shading
	wall schedule		Width [mm]	0.50	Ho fea		J Vartical s	shading
External	wall schedule	Height			Ho fea	orizontal shading	Vertical s	shading
External v	wall schedule Wall ID	Height [mm]	[mm]	Orientation	Ho fea	orizontal shading ature* maximum orojection [mm]	Vertical s	shading
External v	wall schedule Wall ID EW-1	Height [mm]	[mm] 14000	Orientation S	Ho fea	orizontal shading ature* maximum orojection [mm] 0	Vertical s feature [shading
External v Location Garage Garage	wall schedule Wall ID EW-1	Height [mm] 2400 2400	[mm] 14000 6000	Orientation S W	Ho fea	orizontal shading ature* maximum orojection [mm] 0	Vertical s feature (shading
External V Location Garage Garage Garage	wall schedule Wall ID EW-1 EW-1 EW-1	Height [mm] 2400 2400	[mm] 14000 6000 2400	Orientation S W N	Ho fea	orizontal shading ature* maximum orojection [mm] 0 0	Vertical s feature [No No	shading
External v Location Garage Garage Garage Garage	wali schedule Wali ID EW-1 EW-1 EW-1	Height [mm] 2400 2400 2400 2400	[mm] 14000 6000 2400 9345	Orientation S W N	Ho fea	orizontal shading ature* maximum rrojection [mm] 0 0 0	Vertical s feature [No No No	shading
External N Location Garage Garage Garage Garage Garage	Wall schedule Wall ID EW-1 EW-1 EW-1 EW-1	Height [mm] 2400 2400 2400 2400 2400	[mm] 14000 6000 2400 9345 7550	Orientation S W N N E	Ho fea	orizontal shading ature* maximum rojection [mm] 0 0 0 0	Vertical s feature [: No No No No No	shading
External N Location Garage Garage Garage Garage Garage Garage Stair	Wall schedule Wall ID EW-1 EW-1 EW-1 EW-1 EW-1	Height [mm] 2400 2400 2400 2400 2400 2400	[mm] 14000 6000 2400 9345 7550 4345	Orientation S W N E W	Ho fea	orizontal shading ature* maximum orojection [mm] 0 0 0 0	Vertical of feature [t] No No No No No No No	shading
External v Location Garage Garage Garage Garage Garage Stair	wali schedule Wali ID EW-1 EW-1 EW-1 EW-1 EW-1 EW-1 EW-1 EW-1 EW-1	Height [mm] 2400 2400 2400 2400 2400 2400 2400 240	[mm] 14000 6000 2400 9345 7550 4345 2200	Orientation S W N N E W N	Ho fea	orizontal shading ature' maximum rojection [mm] 0 0 0 0	Vertical s feature [No No No No No	shading
External v Location Garage Garage Garage Garage Garage stair stair	wall schedule Wall ID EW-1 EW-1 EW-1 EW-1 EW-1 EW-1 EW-1 EW-1 EW-1	Height [mm] 2400 2400 2400 2400 2400 2400 2400 240	[mm] 14000 6000 2400 9345 7550 4345 2200 2850	Orientation S W N N E W T E W T E W T E T T E T T T T T T T	Ho fea	rizontal shading sture* maximum rojection [mm] 0 0 0 0 0 0 0	Vertical s feature [No No No No No No No	shading
External v Location Garage Garage Garage Garage Garage stair stair Master Bedro	wall schedule Wall ID EW-1 EW-1 EW-1 EW-1 EW-1 EW-1 EW-1 EW-1 EW-2 Om EW-2	Height [mm] 2400 2400 2400 2400 2400 2400 2400 240	[mm] 14000 8000 2400 9345 7550 4345 2200 2850 995	Orientation S W N N S W N E W N N R	Ho fea	orizontal shading sture' maximum rojection [rm] 0 0 0 0 0 0 0 0 0 0 0 0 0	Vertical 1 feature [the No	shading
External v Location Garage Garage Garage Garage Garage stair stair Master Bedro Master Bedro	wall schedule Wall ID	Height [mm] 2400 2400 2400 2400 2400 2400 2400 240	[mm] 14000 6000 2400 9345 7550 4345 2200 2850 995	Orientation S W N N S W N N E N E N E N E	Ho fea	orizontal shading sture' maximum rejection [rm] 0 0 0 0 0 0 0 0 0 0 0 0 0	Vertical 1 feature [the No	shading
External v Location Garage Garage Garage Garage Garage stair stair Master Bedro Master Bedro Master Bedro Master Bedro	wall schedule Wall ID EW-1 EW-1 EW-1 EW-1 EW-1 EW-1 EW-1 EW-1 EW-2 Oom EW-2 Oom EW-2 Oom EW-2 Oom EW-2	Height [mm] 2400 2400 2400 2400 2400 2400 2400 240	[mm] 14000 6000 2400 9345 7550 4345 2200 2850 995 4550 680	Orientation S W N N N N E E N E E E E	Ho fea	rrizontal shading sture' maximum rojection [mm] 0 0 0 0 0 0 0 0 0 0 0 0 0 0 0 0 0 0	J Vertical s feature [1] No	shading

	Approva	I Stage	Constru Stage	ction	
Certificate check	cked	ority/	pe	ority	ther
Continued	Assessor checked	Consent Authority Survey or checked	Builder checked	Consent Authority Survey or checked	Occupancy/Other
Additional NCC requirements for thermal performance (not incl.	uded in t	he NatHI	RS asse	ssment)	
Thermal bridging					
Does the dwelling meet the NCC requirement for thermal bridging?					
Insulation installation method					
Has the insulation been installed according to the NCC requirements?					
Building sealing					
Does the dwelling meet the NCC requirements for Building Sealing?					
Whole of Home performance check (not applicable if a Whole of Hom	e performa	ance asse	ssment is	not conduc	ted)
Appliances					
Does the cooling appliance's type, location and efficiency/performance shown on the NatHERS-stamped plans or as installed match the location and minimum efficiency/performance requirements shown in the Appliance schedule on this Cortificate?					
Does the heating appliance/s type, location and efficiency/performance shown on the NatHERS-stamped plans or installed, match the location and minimum efficiency/performance requirements shown in the 'Appliance schedule					Г
Does the hot water system type and efficiency/performance shown on the NatHERS- stamped plans or as installed match the location and minimum efficiency/performance requirements shown in the 'Appliance schedule' on this Certificate?					Г
Does the pool pump efficiency/performance shown on the NatHERS-stamped plans or as installed match the minimum efficiency/performance requirements shown in the 'Appliance schedule' on this Certificate?					
Does the onsite renewable energy system type, orientation and system size or generation capacity shown on the NathERS stamped plans or installed match the 'Onsite Renewable Energy schedule' on this Certificate?					
Additional NCC Requirements for Services (not included in the	NatHERS	assess	ment)		
Does the lighting meet the artificial lighting requirements specified in the NCC?					
Does the hot water system meet the additional requirements specified in the NCC?					
Provisional values* check					
Have provisional values* been used in the assessment and, if so, are they noted in 'Additional notes' table below?					
Other NCC requirements					
Note: This Certificate only covers the energy efficiency requirements in the NCC. Add but are not limited to: condensation, structural and fire safety requirements and any s requirements.					
Additional notes					

Location	Wall ID	Height [mm]	Width [mm]	Orientation	featu	zontal shad ure* maximi ejection [mn	Jm Feature No	
master ens	EW-2	3000	2190	s	pro	0	No	
Bedroom 2	EW-2	3000	3290	s		0	No	
Bedroom 3	EW-2	3000	3390	s		0	No	
Kitchen/Living	EW-2	3000	5495	S		0	No	
Kitchen/Living	EW-2	3000	10395	W		4950	No	
bath	EW-2	3000	945	W		4950	No	
bath	EW-2	3001	450	W		0	No	
bath	EW-2	3000	3695	N		0	No	
Wip	EW-2	3000	645	N		0	No	
Wip	EW-2	3000	900	W		0	No	
Wip	EW-2	3000	3195	N		0	No	
ldry	EW-2	3000	4045	N		0	No	
ldry	EW-2	3000	500	E		0	No	
Bedroom 4	EW-2	3000	3895	E		1850	No	
Bedroom 4	EW-2	3000	3445	N		0	No	
entry	EW-2	3000	580	N		3860	No	
entry	EW-2	3000	743	NE		1522	No	
entry	EW-2	3000	1350	E		750	No	
entry	EW-2	3000	376	Е		3562	No	
IW-002 Timber					Area [n 3.72 172.6 12.15	No insu	lation	2.7
Floor type	Constru	ıction		Area [m²]	Sub-floor ventilation	Added insulation [R-value]	Covering	
Garage	Concret 200mm	le Slab on	Ground	98.28	None	Bulk Insulation, Gap to Floor R2	Bare	

NOTES

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PROPOSED DWELLING | DRAWING

YAGOONA NSW 2199

DESIGN NATALI DUNDOVIC

DRAFTED SARA PETROVSKA

4 CALDWELL PARADE

NATHERS COMMITMENTS

DWG No. 24199 - 930 ROLA EL ECHE ISSUE A

es.au

0012004909 NatHERS Cer	tificate 7 Star Rating as of	24 Jun 2025			HOUSE
Location	Construction	Area [m²]	Sub-floor ventilation	Added insulation [R-value]	Covering
stair	Concrete Slab on Ground 200mm	9.40	None	Bulk Insulation, Gap to Floor R2	Ceramic Tiles 8mm
Master Bedroom / Garage	Concrete Timber Framed Above Plasterboard 200mm	18.21		No Insulation	Ceramic Tiles 8mm
Master Bedroom	Suspended Concrete Slab 200mm	6.78	Totally Open	Bulk Insulation, Gap to Floor R2	Ceramic Tiles 8mm
master wir / Garage	Concrete Timber Framed Above Plasterboard 200mm	7.05		No Insulation	Ceramic Tiles 8mm
master wir	Suspended Concrete Slab 200mm	0.83	Totally Open	Bulk Insulation, Gap to Floor R2	Ceramic Tiles 8mm
master ens / Garage	Concrete Timber Framed Above Plasterboard 200mm	5.71		No Insulation	Ceramic Tiles 8mm
Bedroom 2 / Garage	Concrete Timber Framed Above Plasterboard 200mm	16.10		No Insulation	Ceramic Tiles 8mm
Bedroom 3 / Garage	Concrete Timber Framed Above Plasterboard 200mm	16.59		No Insulation	Ceramic Tiles 8mm
Kitchen/Living / Garage	Concrete Timber Framed Above Plasterboard 200mm	9.91		No Insulation	Ceramic Tiles 8mm
Kitchen/Living	Suspended Concrete Slab 200mm	49.86	Totally Open	Bulk Insulation, Gap to Floor R2	Ceramic Tiles 8mm
bath	Suspended Concrete Slab 200mm	4.81	Totally Open	Bulk Insulation, Gap to Floor R2	Ceramic Tiles 8mm
Wip	Suspended Concrete Slab 200mm	8.04	Totally Open	Bulk Insulation, Gap to Floor R2	Ceramic Tiles 8mm
ldry	Suspended Concrete Slab 200mm	8.84	Totally Open	Bulk Insulation, Gap to Floor R2	Ceramic Tiles 8mm
Bedroom 4	Suspended Concrete Slab 200mm	14.03	Totally Open	Bulk Insulation, Gap to Floor R2	Ceramic Tiles 8mm
entry / Garage	Concrete Timber Framed Above Plasterboard 200mm	12.34		No Insulation	Ceramic Tiles 8mm
entry / stair	Concrete Timber Framed Above Plasterboard 200mm	2.47		No Insulation	Ceramic Tiles 8mm

 $^{\circ}$ Refer to glossary. Generated on 24 Jun 2025 using BERS Pro v5.2.4 (3.23) for 4 Caldwell Parade , YAGOONA , NSW , 2199 Page 9 of 13

HOUSE

Explanatory notes

AFRC	Australian Fenestration Rating Council
Annual energy load	the predicted amount of energy required for heating and cooling, based on standard occupancy assumptions.
Assessed floor area	the floor area modelled in the software for the purpose of the NatHERS assessment. Note, this may not be consistent with t
Assessed floor area	floor area in the design documents.
Ceiling penetrations	features that require a penetration to the ceiling, including downlights, vents, exhaust fans, range hoods, chimneys and flue Excludes lixtures attached to the ceiling with small holes through the ceiling for wining, e.g. ceiling fans; pendant lights, and heating and cooling ducts.
COP	Coefficient of performance
Conditioned	a zone within a dwelling that is expected to require heating and cooling based on standard occupancy assumptions. In some circumstances it will include garages.
Custom windows	windows listed in NatHERS software that are available on the market in Australia and have a WERS (Window Energy Ratin Scheme) rating.
Default windows	windows that are representative of a specific type of window product and whose properties have been derived by statistical methods.
EER	Energy Efficiency Ratio, measure of how much cooling can be achieved by an air conditioner for a single KWh of electricity input
Energy use	This is your homes rating without solar or batteries.
Energy value	The net cost to society including, but not limited to, costs to the building user, the environment and energy networks (as defined in the ABCB Housing Provisions Standard).
Entrance door	these signify ventilation benefits in the modelling software and must not be modelled as a door when opening to a minimally ventilated comdor in a Class 2 building.
Exposure	see exposure categories below.
Exposure category – exposed	terrain with no obstructions e.g. flat grazing land, ocean-frontage, desert, exposed high-rise unit (usually above 10 floors).
Exposure category – open	terrain with few obstructions at a similar height e.g. grasslands with few well scattered obstructions below 10m, farmland wit scattered sheds, lightly vegetated bush blocks, elkvåted units (e.g. above 3 floors).
Exposure category – protected	terrain with numerous, closely spaced obstructions below 10m e.g. suburban housing, heavily vegetated bushland areas.
Exposure category – suburban	terrain with numerous, closely spaced obstructions over 10 m e.g. city and industrial areas.
Horizontal shading feature	provides shading to the building in the horizontal plane, e.g. eaves, verandahs, pergolas, carports, or overhangs or balconie from upper levels.
National Construction Code (NCC) Class	the NCC groups buildings by their function and use, and assigns a classification code. NatHERS software models NCC Class 1, 2 or 4 buildings and attached Class 10a buildings. Definitions can be found at www.abcb.gov.au.
Net zero home	a home that achieves a net zero energy value*.
Opening percentage	the openability percentage or operable (moveable) area of doors or windows that is used in ventilation calculations.
Provisional value	an assumed value that does not represent an actual value. For example, if the wall colour is unspecified in the documentation a provisional value of medium must be modelled. Acceptable provisional values are outlined in the Nati ERS Technical Not and can be found at www.nathers.gov.au
Recommended capacity	this is the capacity or size of equipment that is recommended by NatHERS to achieve the desired comfort conditions in the zone or zones serviced. This is a recommendation and the final selection sizing should be confirmed by a suitably qualified nerson.
Reflective wrap (also known as foil)	can be applied to walls, roofs and ceilings. When combined with an appropriate airgap and emissivity value, it provides insulative properties.
Roof window	for NatHERS this is typically an operable window (i.e. can be opened), will have a plaster or similar light well if there is an all space, and generally does not have a diffuser.
Shading features	includes neighbouring buildings, fences, and wing walls, but excludes eaves.
Skylight (also known as roof light:	s) for NatHERS this is typically a moulded unit with flexible reflective tubing (light well) and a diffuser at ceiling level.
Solar heat gain coefficient (SHGC)	the fraction of incident solar radiation admitted through a window, both directly transmitted as well as absorbed and subsequently released inward. SHGC is expressed as a number between 0 and 1. The lower a window's SHGC, the less so heat it transmits.
STCs	Small-scale Technology Certificates, certificates created by the REC registry for renewable energy technologies that may be bought and sold as part of the Small-scale Renewable Energy Scheme operated by the Clean Energy Regulator (CER)
Thermal breaks	are materials with an R-value greater than or equal to 0.2 that must separate the metal frame from the cladding. This include but is not limited to, materials such as briber batters greater than or equal to 20mm thick or continuous thermal breaks such as polystyrene insulation, sheeting or classic strips.
U-value	the rate of heat transfer through a window. The lower the U-value, the better the insulating ability.
Unconditioned	a zone within a dwelling that is assumed to not require heating and cooling based on standard occupancy assumptions.
Vertical shading features	provides shading to the building in the vertical plane and can be parallel or perpendicular to the subject walf-window. Include privacy screens, other walfs in the building (wing walfs), fences, other buildings, vegetation (protected or listed heritage tree
Window shading device	device fixed to windows that provides shading e.g. window awnings or screens but excludes horizontal* or vertical shading features* (eq eaves and balconies)

HOUSE Ceiling type Bulk insulation R-value Reflective (may include edge batt values) wrap* [yes/no] material/type Concrete, Plasterboard with Timber Frame Bulk Insulation R2.5 Concrete Timber Framed Above Plasterboard No Insulation Master Bedroom Plasterboard on Timber Bulk Insulation R6 master wir Plasterboard on Timber Bulk Insulation R6 Bulk Insulation R6 Bedroom 3 Plasterboard on Timber Bulk Insulation R6 Kitchen/Living Plasterboard on Timber Bulk Insulation R6 Plasterboard on Timber Bulk Insulation R6 Bulk Insulation R6 Plasterboard on Timber Plasterboard on Timber Bulk Insulation R6 Ceiling penetrations* Quantity Type
5 Downlights - LED 0 Sealed 2 Downlights - LED Sealed 3 Downlights - LED 3 Downlights - LED Sealed 12 Downlights - LED Sealed 1 Exhaust Fans

* Refer to glossary. Generated on 24 Jun 2025 using BERS Pro v5.2.4 (3.23) for 4 Caldwell Parade , YAGOONA , NSW , 2199

Nip dry		antity Type		Diameter [mr	n] Sealed/unse	ealed
dry		2 Downlights	- LED	0	Sealed	
		1 Exhaust Far	ns	350	Sealed	
Bedroom 4		3 Downlights	- LED	0	Sealed	
entry		8 Downlights	- LED	0	Sealed	
Ceiling fans						
ocation		Quantity	у	D	iameter [mm]	
No Data Available						
Roof type		Added insulation			Solar	Roof shad
Construction		[R-value]			absorptanc	e [colour]
Naterproofing Memb	rane	No Insulation, Only	an Air Gap		0.50	Medium
Corrugated Iron Timb	er Frame	Bulk, Reflective Sid	de Down, No Air G	ap Above R1.3	0.50	Medium
Building element		tion dimensions width, mm]	Frame space		Steel thickness [BMT,mm]	Thermal break [R-value]
	[height x		Frame spac			break
No Data Available Appliance sch	[height x		e assessment is	s not conducte	[BMT,mm]	break [R-value]
No Data Available Appliance sch	[height x	width, mm] Home performanc	e assessment is	s not conducte	[BMT,mm]	break [R-value]
Appliance sch not applicable if a	[height x redule a Whole of I on of 5W/m ² i	width, mm] Home performanc	e assessment is	s not conducte	[BMT,mm] If for this certific appliance schedule in Reco	break [R-value]
Appliance sch not applicable if a Note: A flat assumptio	[height x redule a Whole of I on of 5W/m ² i	width, mm] Home performancs sused for lighting, the	e assessment is	s not conducte tot included in the Minimur efficienc	[BMT,mm] If for this certific appliance schedule in Reco	break [R-value]
Appliance sch not applicable if a kote: A flat assumptic Cooling system Appliance/ system t	[height x redule a Whole of I on of 5W/m ² i	width, mm] Home performancs sused for lighting, the	e assessment is	s not conducte tot included in the Minimur efficienc	[BMT,mm] If for this certific appliance schedule in Reco	break [R-value]
Appliance Sch not applicable if a lote: A flat assumptic cooling system Appliance/ system t No Data Available	[height x	width, mm] Home performancs sused for lighting, the	e assessment is	s not conducte tot included in the Minimur efficienc	Is for this certific appliance schedule in Reco	break [R-value]

Hot water system Appliance/ system type Fuel type Water efficiency Stem type Fuel type CRZ foot of Stem 1 foot of Stem 1 foot of Stem 2 foot of Appliance/ system type No Data Available Onsite Renewable Energy Schedule System Size Or Generation Capacity Battery Schedule No Data Available * Refer to glossary. Generated on 24 Jun 2025 using BERS Pro v5.2.4 (3.23) for 4 Caldwell Parade , YAGOONA , NSW , 2199 Page 12 of 13

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PROPOSED DWELLING DRAWING

4 CALDWELL PARADE YAGOONA NSW 2199


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PROPOSED DWELLING DRAWING

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SHADOW DIAGRAMS - 21st JUNE

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PROPOSED DWELLING DRAWING

4 CALDWELL PARADE YAGOONA NSW 2199

REAR 3D VIEW

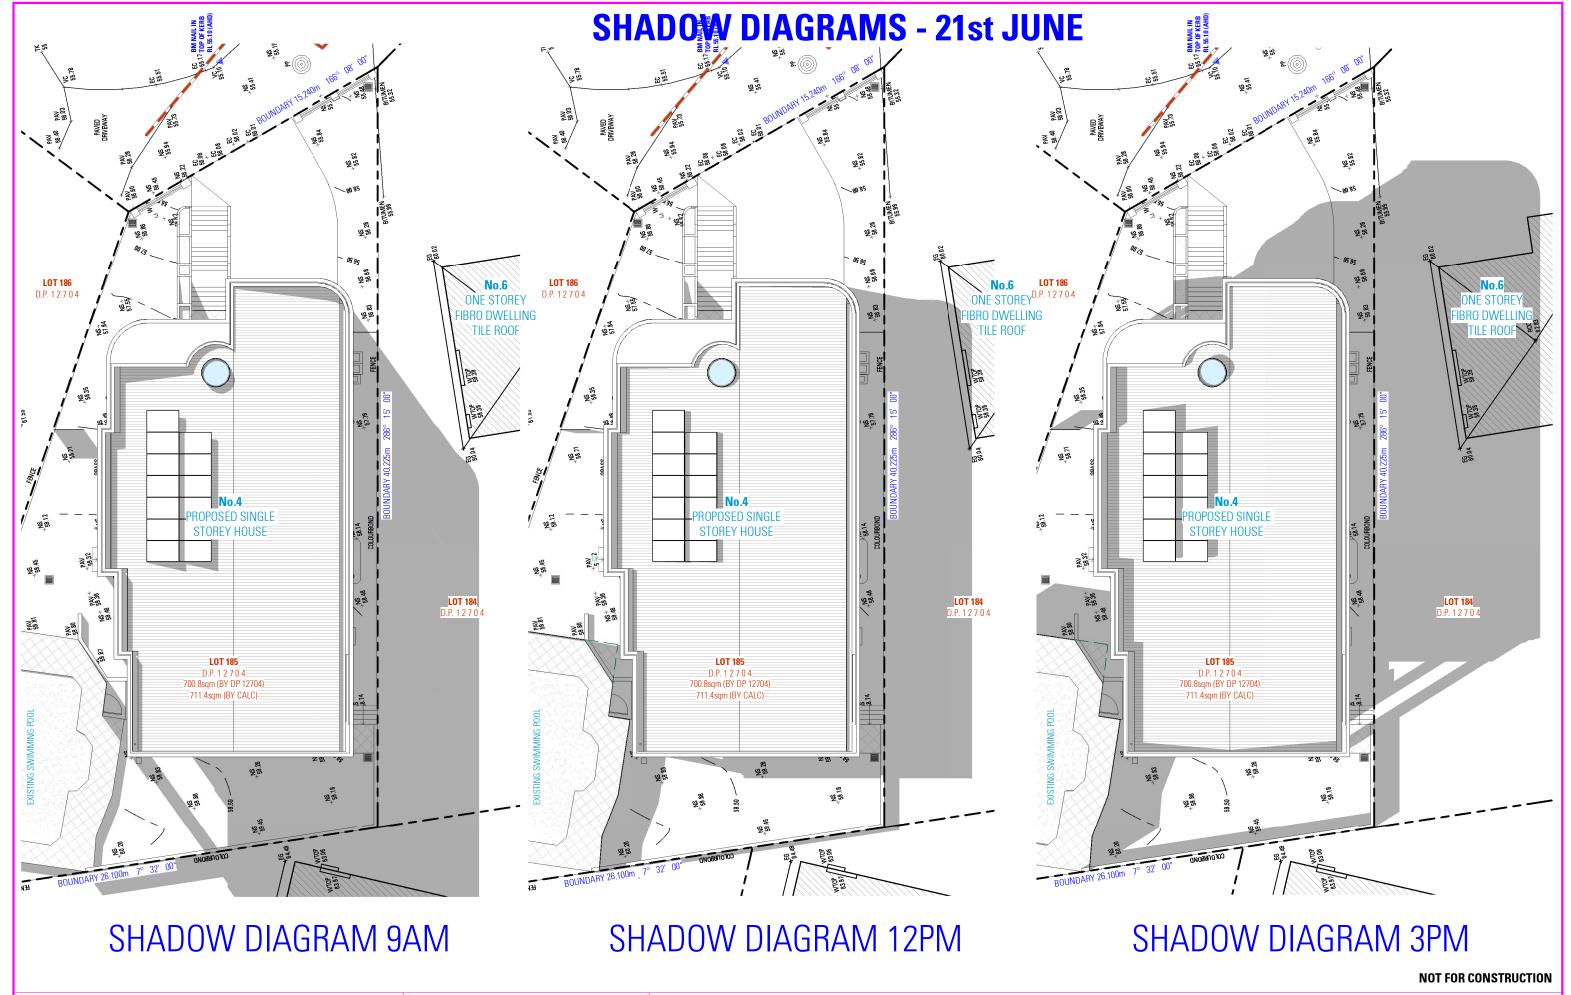ROLA EL ECHE ISSUE A

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